

SCALE: 1" = 500'

CITY OF WALLINGFORD, CONNECTICUT

PLAN FOR REHABILITATION OF SOUTH TURNPIKE ROAD CULVERT OVER MANSION BROOK

BRIDGE #148-028

ROAD CLASSIFICATION: URBAN COLLECTOR 85th PERCENTILE SPEED (Connecticut Counts LLC): 49 MPH 2016 ADT (Connecticut Counts LLC): 7417 V.P.D.

	LIST OF DRAWINGS							
SHEET NO.	TITLE							
1	COVER SHEET							
2	DETAILED ESTIMATE SHEET							
3	EXISTING PLAN AND ELEVATIONS							
4	ROADWAY PLAN							
5	ROADWAY PROFILE							
6	ROADWAY CROSS SECTIONS-1							
7	ROADWAY CROSS SECTIONS-2							
8	MAINTENANCE AND PROTECTION OF TRAFFIC							
9	HANDLING WATER PLANS							
10	HANDLING WATER DETAILS							
11	EASEMENT MAP							
12	EROSION AND SEDIMENTATION CONTROL DETAILS							
13	STRUCTURE PLAN AND SECTIONS							
14	MISCELLANEOUS DETAILS							
15	ROCK VANE DETAILS							

TECHNICAL SPECIFICATIONS: STATE OF CONNECTICUT DEPARTMENT
OF TRANSPORTATION STANDARDS: ABAITO POLICY ON THE GEOMETRIC DESIGN
DESIGN STANDARDS: ABAITO POLICY ON THE GEOMETRIC DESIGN
OF HIGHWAYS AND STREETS, DATED 2004 AND THE CONNECTICUT
DEPARTMENT OF TRANSPORTATION HIGHWAY DESIGN MANUAL
DATED 2003.

SURVEY: ALL COORDINATES ON THE PROJECT ARE BASED ON N.A.D.

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REGION NO.

WALLINGFORD

MASSACHUSETTS

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83/87. ALL ELEVATIONS ARE BASED ON N.A.V.D 88.

IT IS THE RESPONSIBILITY OF EACH BIDDER AND ALL OTHER INTERESTED PARTIES TO OBTAIN ALL BIDDING RELATED INFORMATION AND DOCUMENTS FROM OFFICIAL SOURCES WITHIN THE CITY OF WALLINGFORD.

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DESIGNED BY _	WMC CONSULTING ENGINEERS	

SUBMITTED BY _____ DATE ____

CITY MANAGER - CITY OF WALLINGFORD

_____ DATE _____

THE INFORMATION, INCLUDING ESTIMATED QUANTITIES OF WORK SHOWN ON THESE SHEETS IS BASED ON LIMITED INVESTIGATIONS BY THE TOWN AND IS IN NO WAY WARRANTED TO INDICATE THE TRUE CONDITIONS OR ACTUAL QUANTITIES OR DISTRIBUTION OF QUANTITIES OF WORK WHICH WILL BE REQUIRED.

		REVISIONS	DATE	11/19/2020
NO.	DATE	DESCRIPTION		
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				K.O.E
			DESIGN	
			JSUPV.	J.A.C.

CONSULTING ENGINEERS

• WENGELL, McDONNELL & COSTELLO • 87 HOLMES ROAD NEWINGTON, CT 06111 (860) 667-9624

PREPARED FOR

TOWN OF WALLINGFORD
45 SOUTH MAIN STREET
WALLINGFORD, CT 06492

REHABILITATION OF SOUTH TURNPIKE ROAD CULVERT OVER MANSION BROOK

DATE: 11/19/2020

D - S. TURNPIKE ROAD - 16032.10 - SIZE PROJECT FILE NAME NUMBER REV. OF 15

COVER SHEET

THE INFORMATION INCLUDING ESTIMATED QUANTITIES OF WORK, SHOWN ON THESE SHEETS IS BASED ON LIMITED INVESTIGATIONS BY THE CITY OF WALLINGFORD IS NO WAY WARRANTED TO INDICATE THE TRUE CONDITIONS OR ACTUAL QUANTITIES OR DISTRIBUTION OF QUANTITIES OF WORK WHICH WILL BE REQUIRED.

WHEREVER THE PAY UNITS IN THE LEFT COLUMN APPEAR ON THE DETAILED ESTIMATE SHEET, THEY SHALL BE CONSTRUED TO MEAN THE EQUIVALENT PAY UNITS IN THE RIGHT COLUMN ON THE PROPOSAL FORM.

c.y. C.Y.

I.f. L.F.

ton TON

s.y. S.Y.

Ib. LB.

s.f. S.F.

gal. GAL.

c.f. C.F.

F.H.W.A REGION NO. STATE TOWN FEDERAL AID PROJECT NO. YEAR ROUTE NO. SHEET N

FOR THE CONSTRUCTION OF REHABILITATION OF SOUTH TURNPIKE ROAD CULVERT OVER MANSION BROOK

___ IN THE CITY OF ____WALLINGFORD, CONNECTICUT

_							ROAD	WAY	ITEMS	5									
	ITEM NUMBER	201001	0202000	202200	0219001	0304002	0703011	0703003	0944001	0950005	0969062	9000260	7000260	0977001	1205216	1220027	0971001	0975002	0980001
	ITEM DESCRIPTION	CLEARING AND GRUBBING	EARTH EXCAVATION	CHANNEL EXCAVATION-EARTH	SEDIMENTATION CONTROL SYSTEM	PROCESSED AGGREGATE BASE	INTERMEDIATE RIPRAP	ROCK WEIR	FURNISHING AND PLACING TOPSOIL	TURF ESTABLISHMENT	CONSTRUCTION FIELD OFFICE, MEDIUM	TRAFFICPERSON (MUNICIPAL POLICE OFFICER)	TRAFFICPERSON (UNIFORMED FLAGGER)	TRAFFIC CONE	TYPE DE-C7 DELINEATOR	CONSTRUCTION SIGN	MAINTAINENCE AND PROTECTION OF TRAFFIC	MOBILIZATION AND PROJECT CLOSEOUT	CONSTRUCTION STAKING
	UNIT	L.S.	C.Y	C.Y.	L.F.	C.Y.	C.Y.	L.F.	S.Y.	S.Y.	MO.	L.S.	HR	EA.	EA.	S.F.	L.S.	L.S.	L.S.
TOT	AL	1	100	60	180	70	75	50	410	410	3	1	200	24	6	200	1	1	1
TOT	AL		100	60	180	70	75	50	410	410	3	1	200	24	6	200	1	1	1
				STR	UCTU	RE IT	EMS			I							<u>I</u>	1	
	ITEM NUMBER	0101002	204151	0204001	0601000	0601070	0601318	0601948	0651645	0653101	0714050								
	ITEM DESCRIPTION	CONFINED SPACE HEALTH AND SAFETY	HANDLING WATER	COFFERDAM AND DEWATERING	CLASS "A" CONCRETE	CLASS "S" CONCRETE	PARITAL DEPTH PATCH	CRACK REPAIR	CENTRIFUGALLY CAST CEMENTITIOUS LINING	CLEAN EXISTING CULVERT- GREATER THAN 42" DIAMTER	TEMPORARY EARTH RETAINING SYSTEM								
	UNIT	L.S.	L.S.	L.F.	C.Y.	C.Y.	C.F.	L.F.	S.Y.	L.F.	S.F.								
TOT	AL	1	1	200	40	2	125	200	150	90	1000	-							
-																			
ТОТ		1	1	200	40	2	125	200	150	90	1000	+							

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		REVISIONS	DATE	11/19/2020
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			5.12 GR25	K.O.E.
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			DESIGN	
				J.A.C.
			SUPV.	J.A.C.
			CLIDV	




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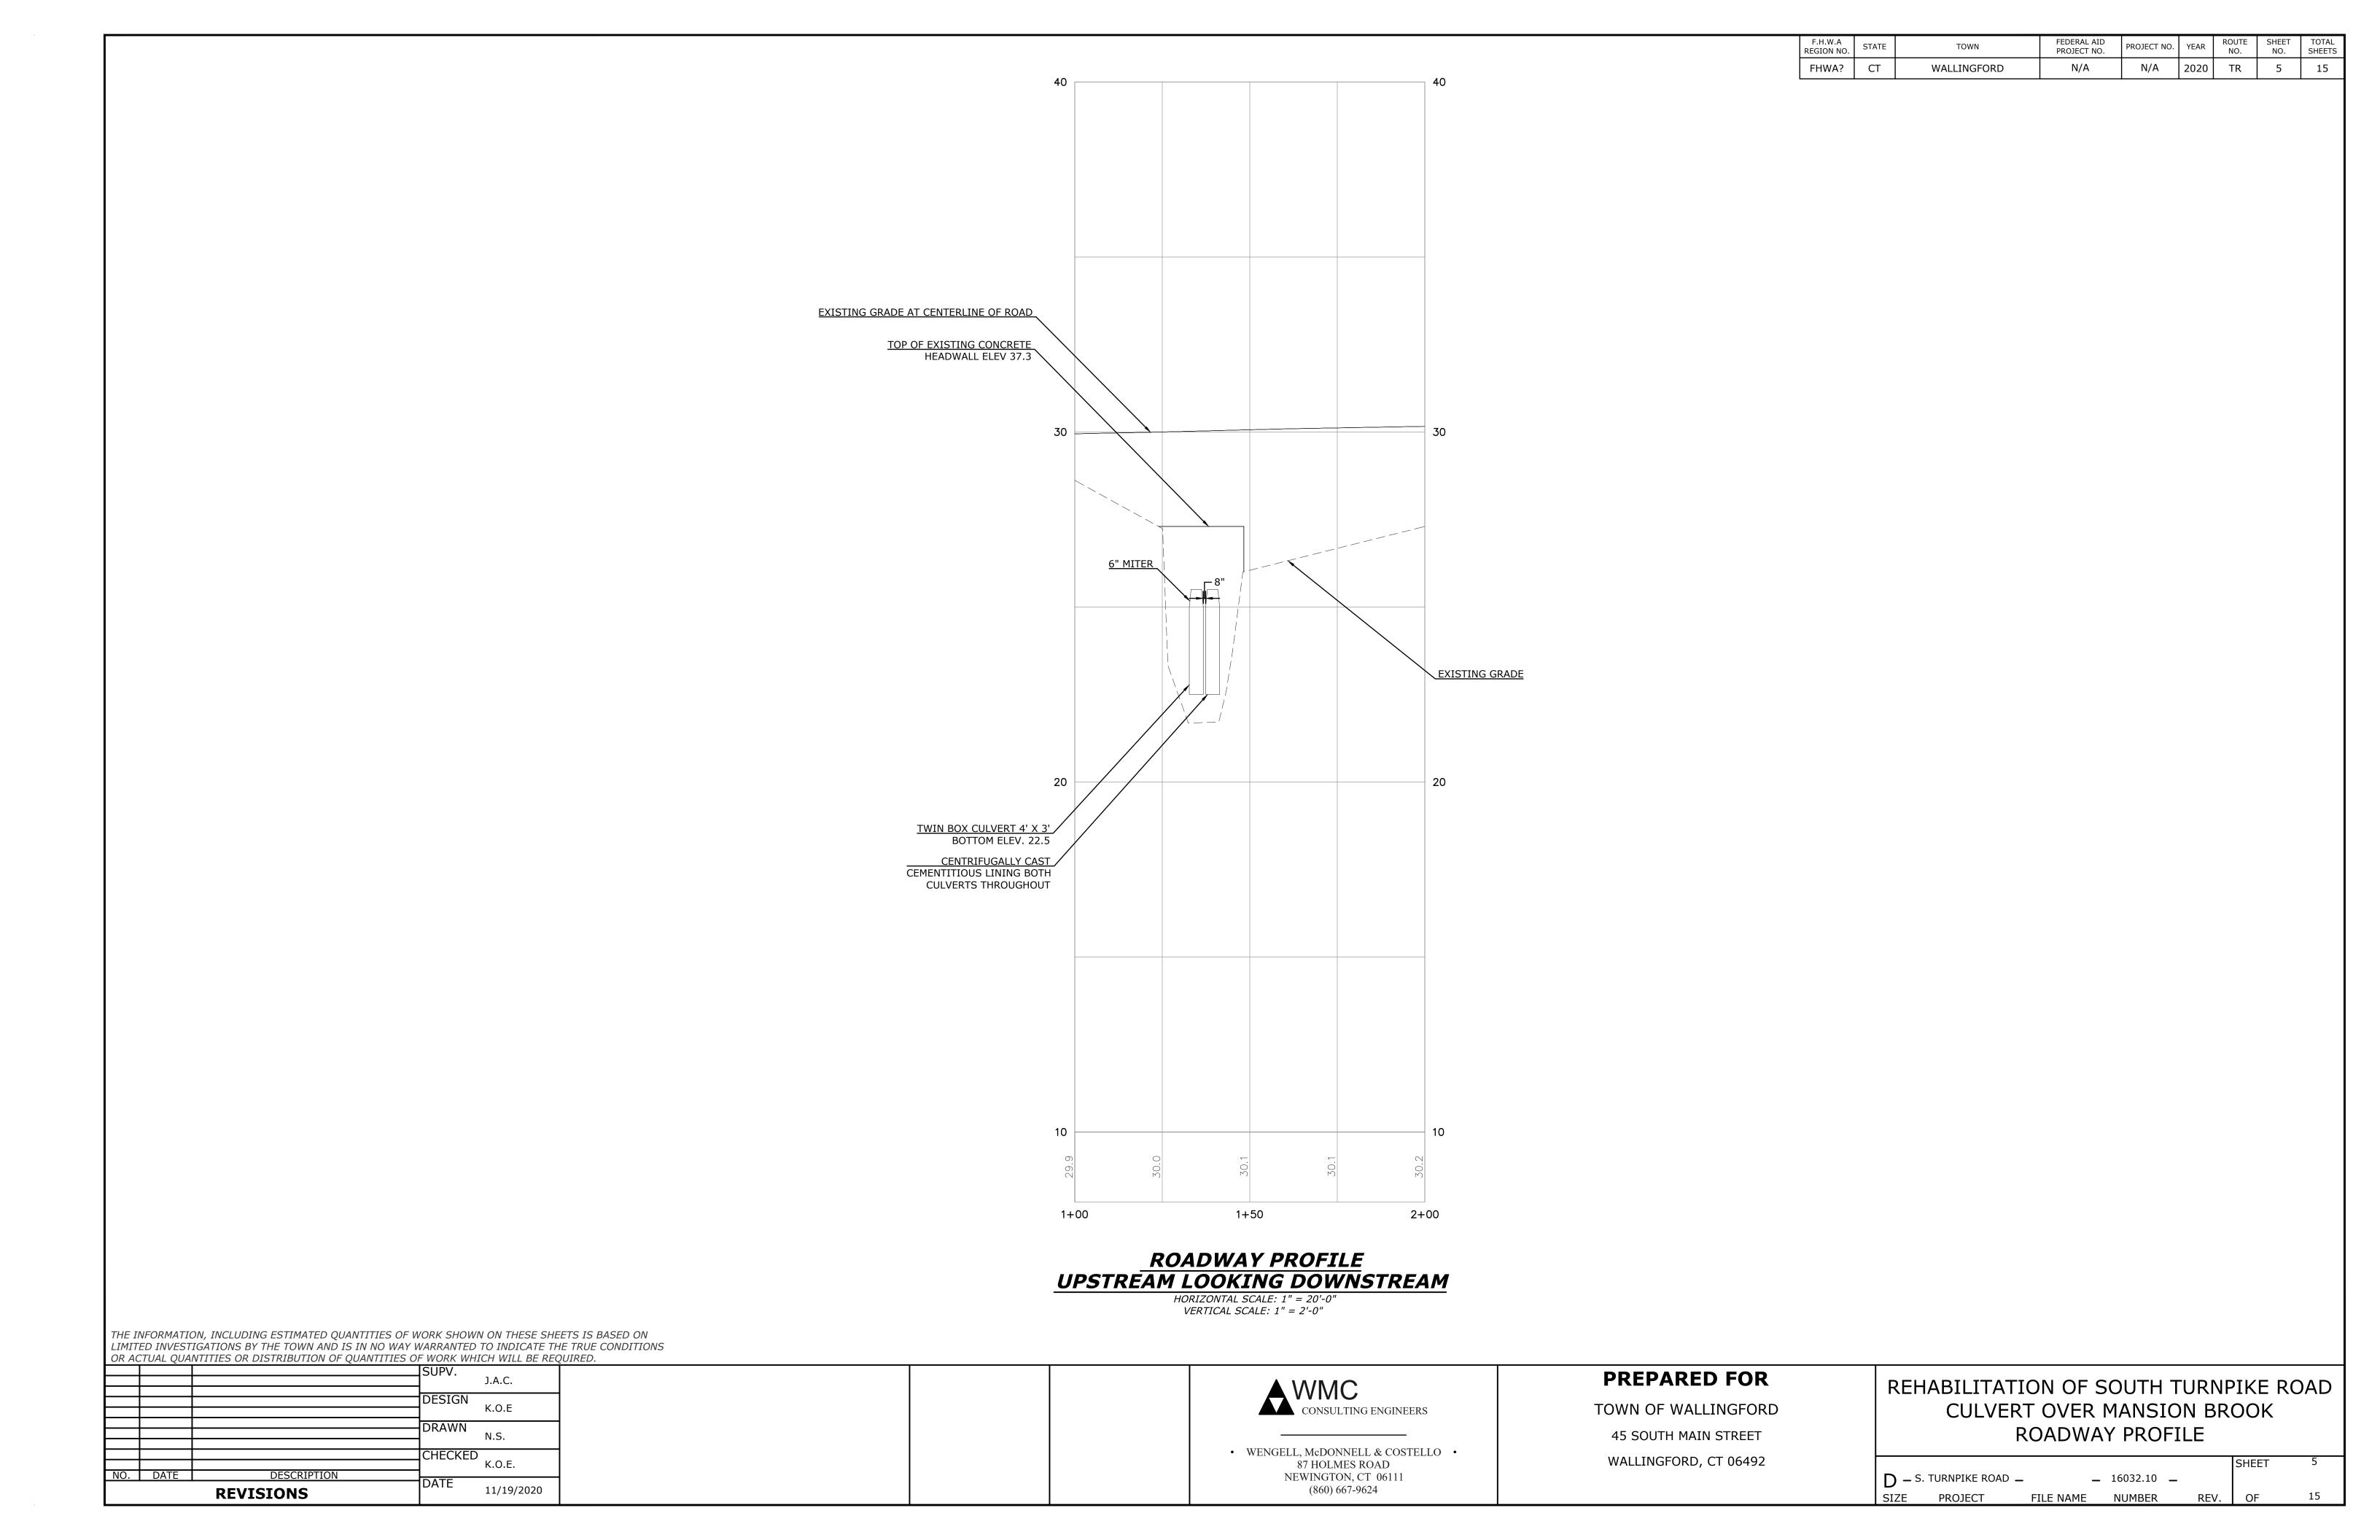
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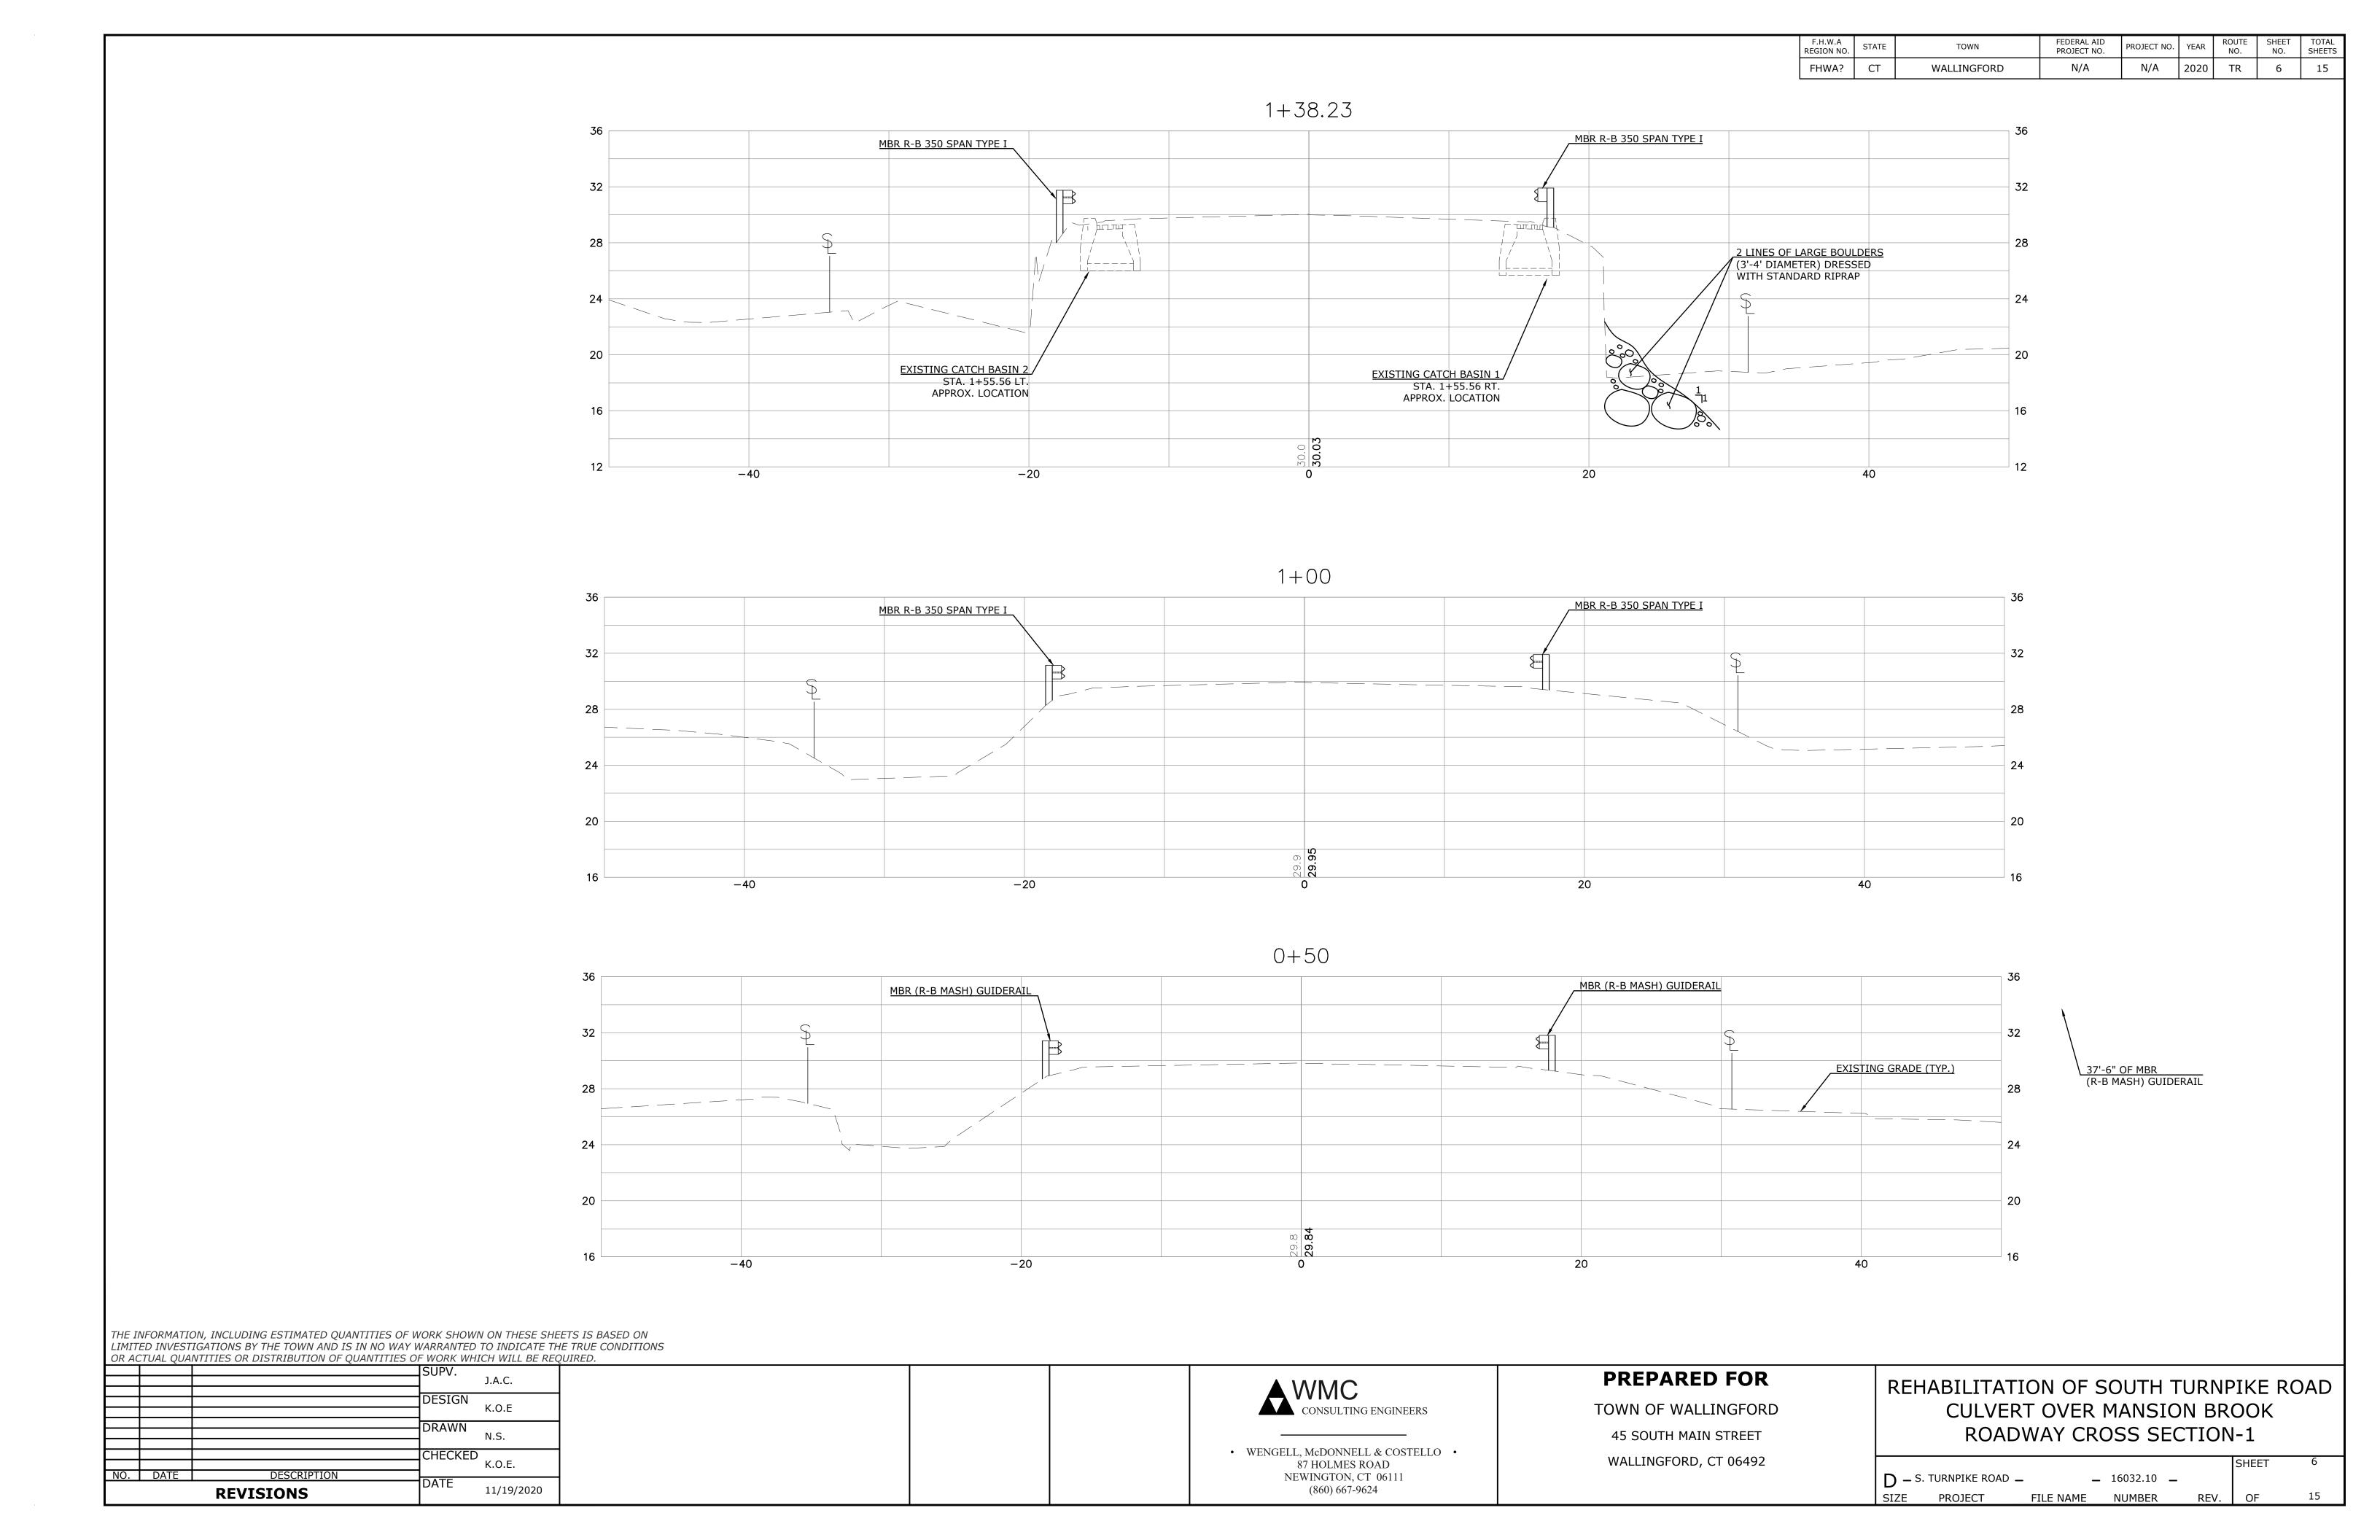
TOWN OF WALLINGFORD
45 SOUTH MAIN STREET
WALLINGFORD, CT 06492

REHABILITATION OF SOUTH TURNPIKE ROAD CULVERT OVER MANSION BROOK DETAILED ESTIMATE SHEET


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D – s	. TURNPIKE ROAD)	16032.10	_			
SIZE	PROJECT	FILE NAME	NUMBER		REV.	OF	15







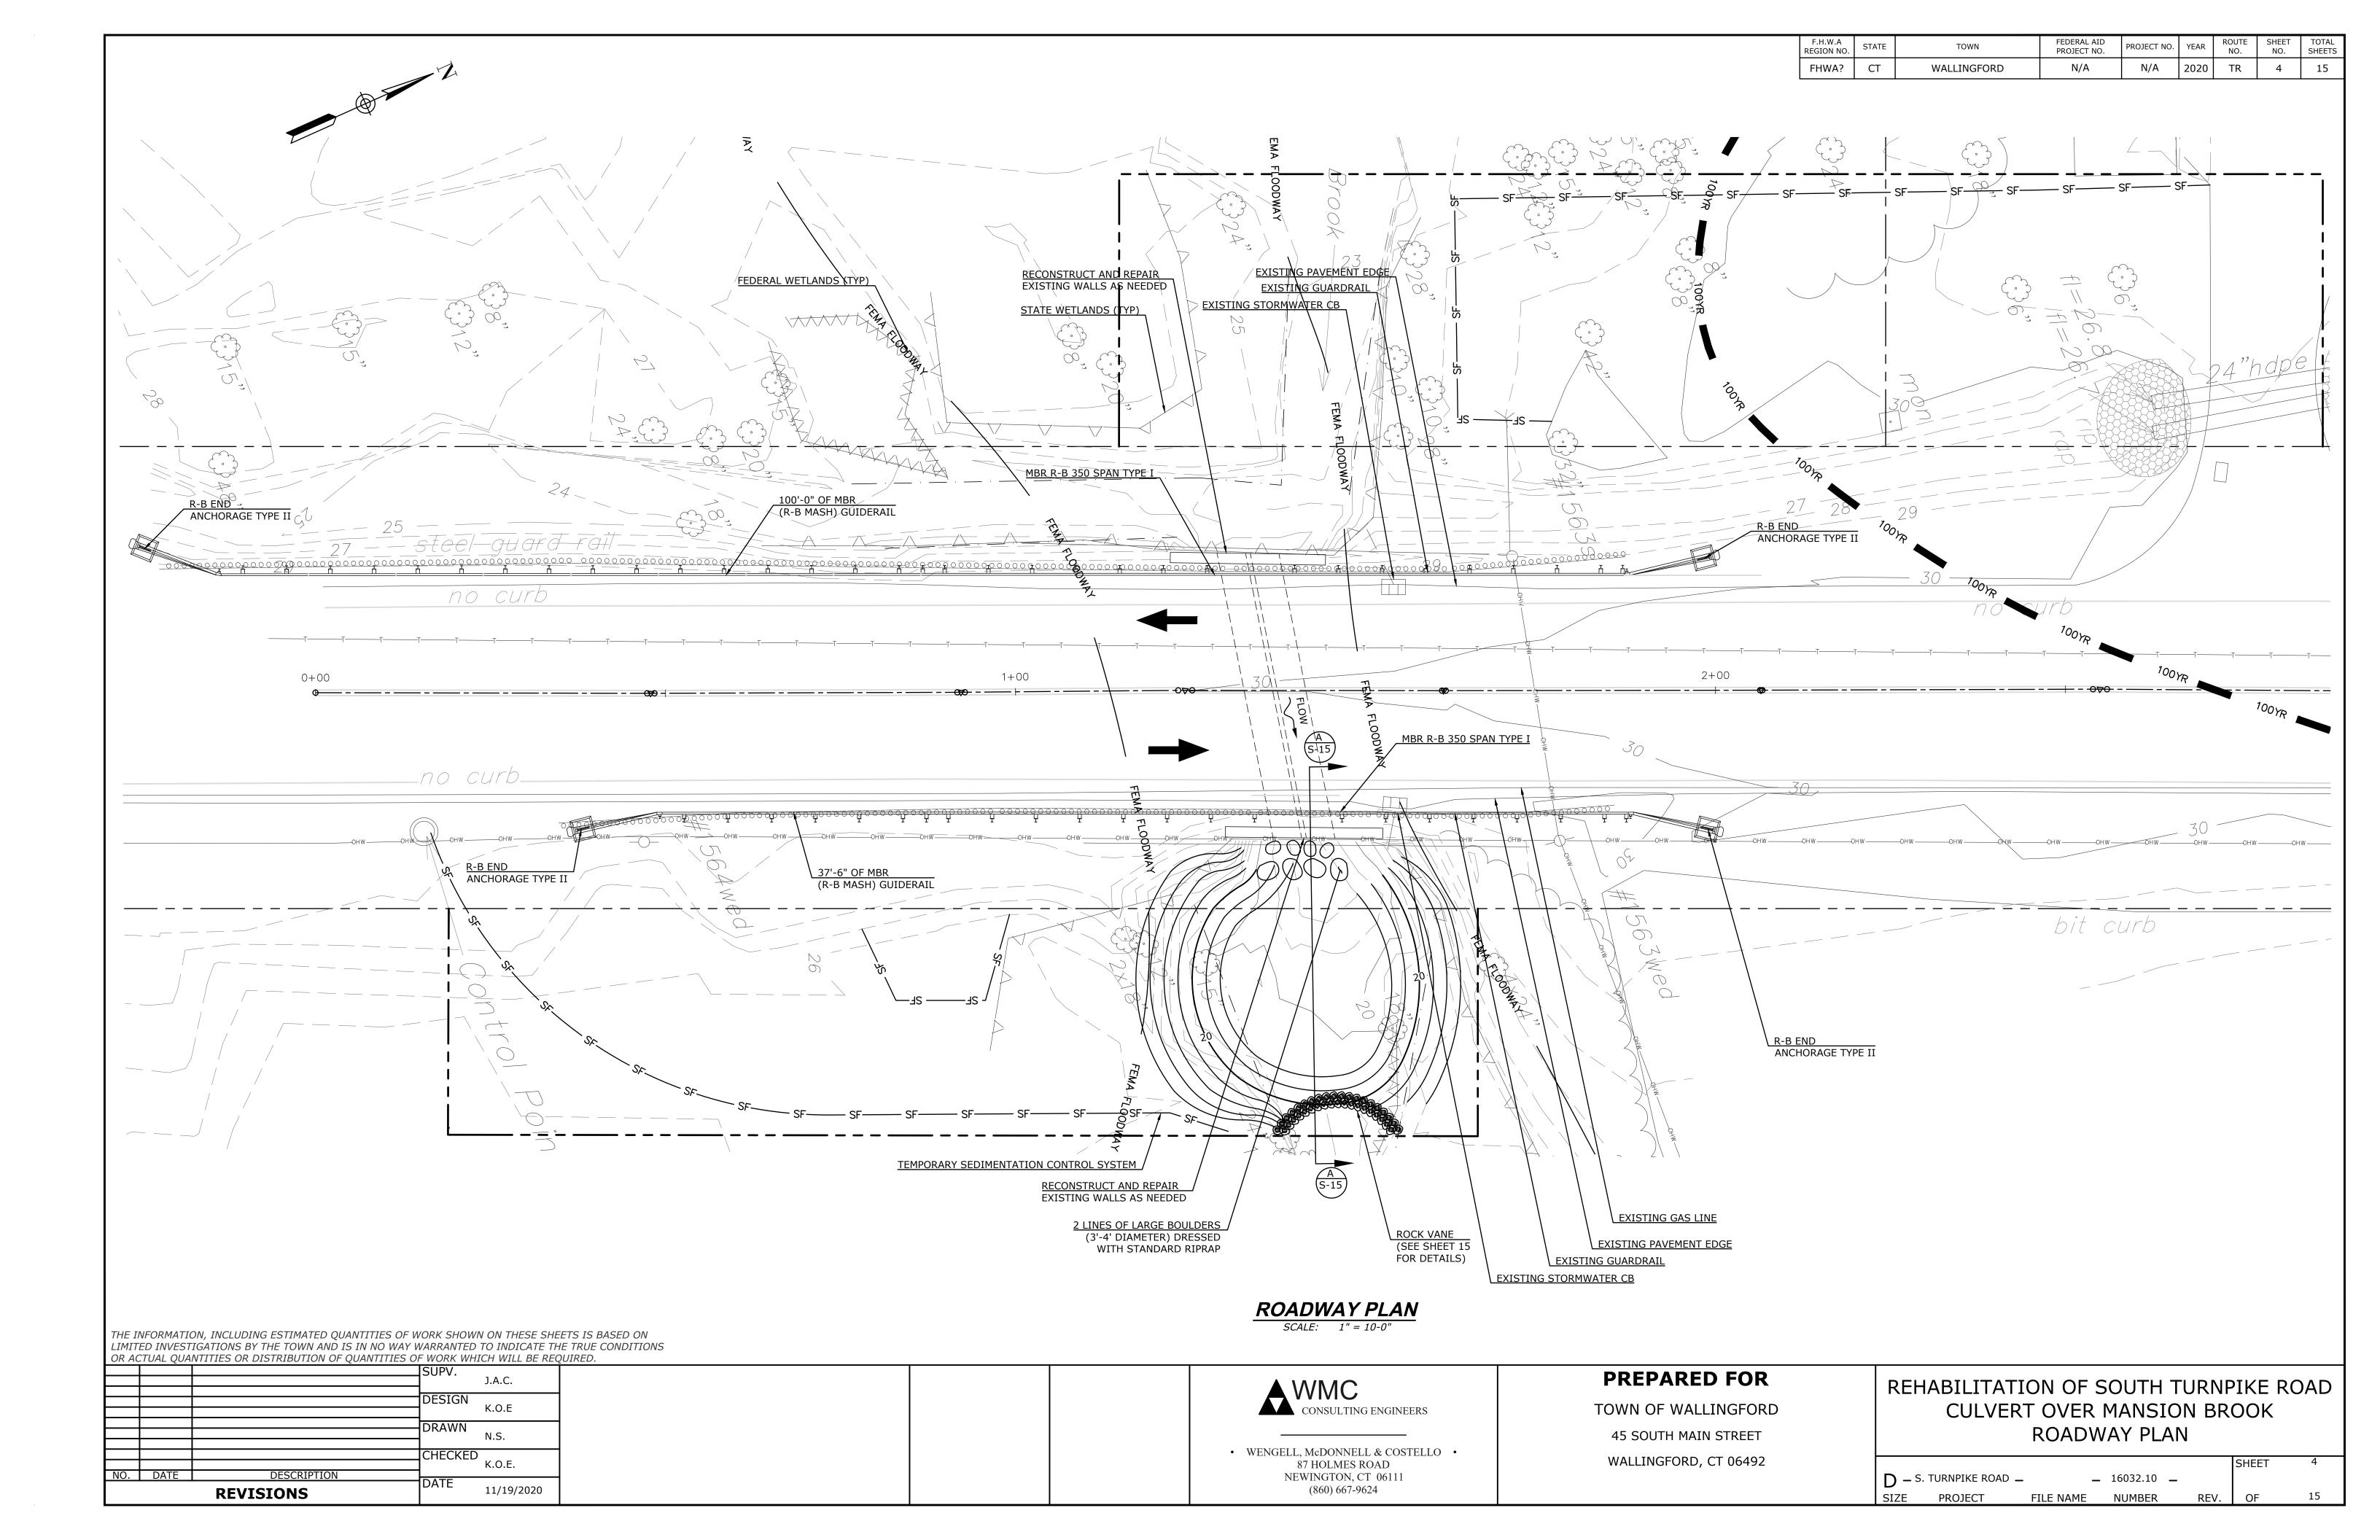

F.H.W.A REGION NO.	STATE	TOWN	FEDERAL AID PROJECT NO.	PROJECT NO.	YEAR	ROUTE NO.	SHEET NO.	TOTAL SHEETS
FHWA?	СТ	WALLINGFORD	N/A	N/A	2020	TR	7	15

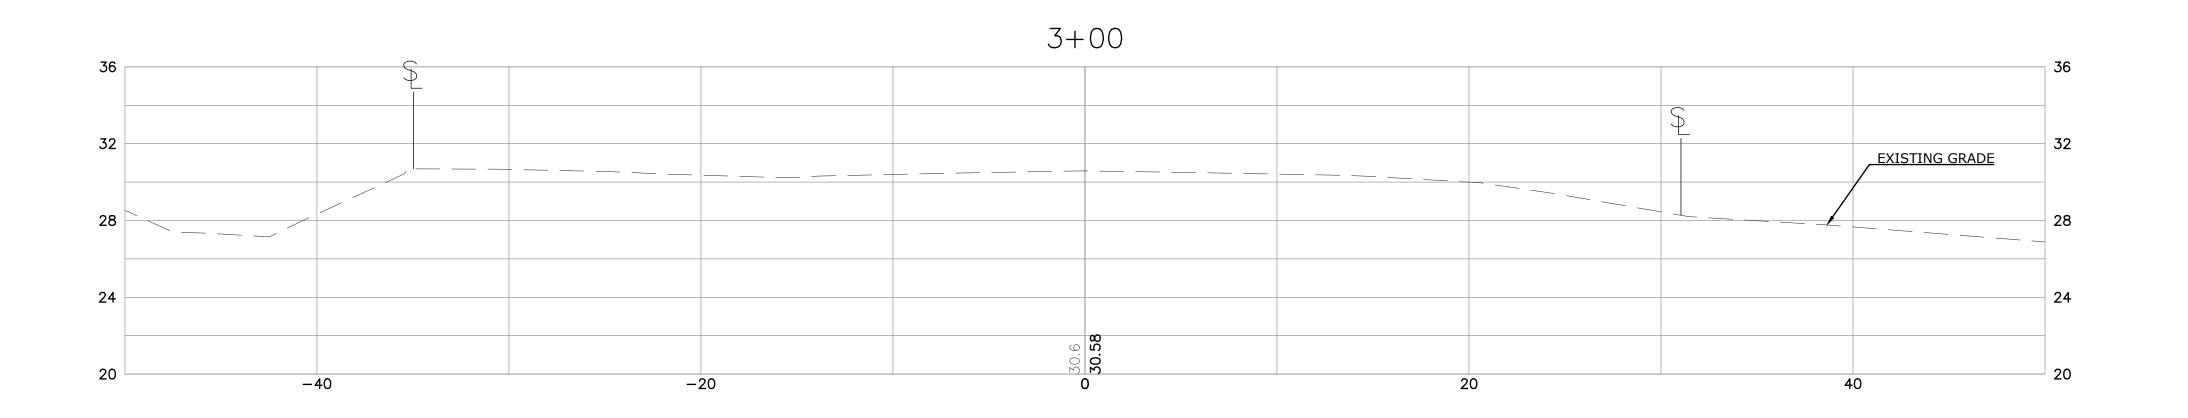

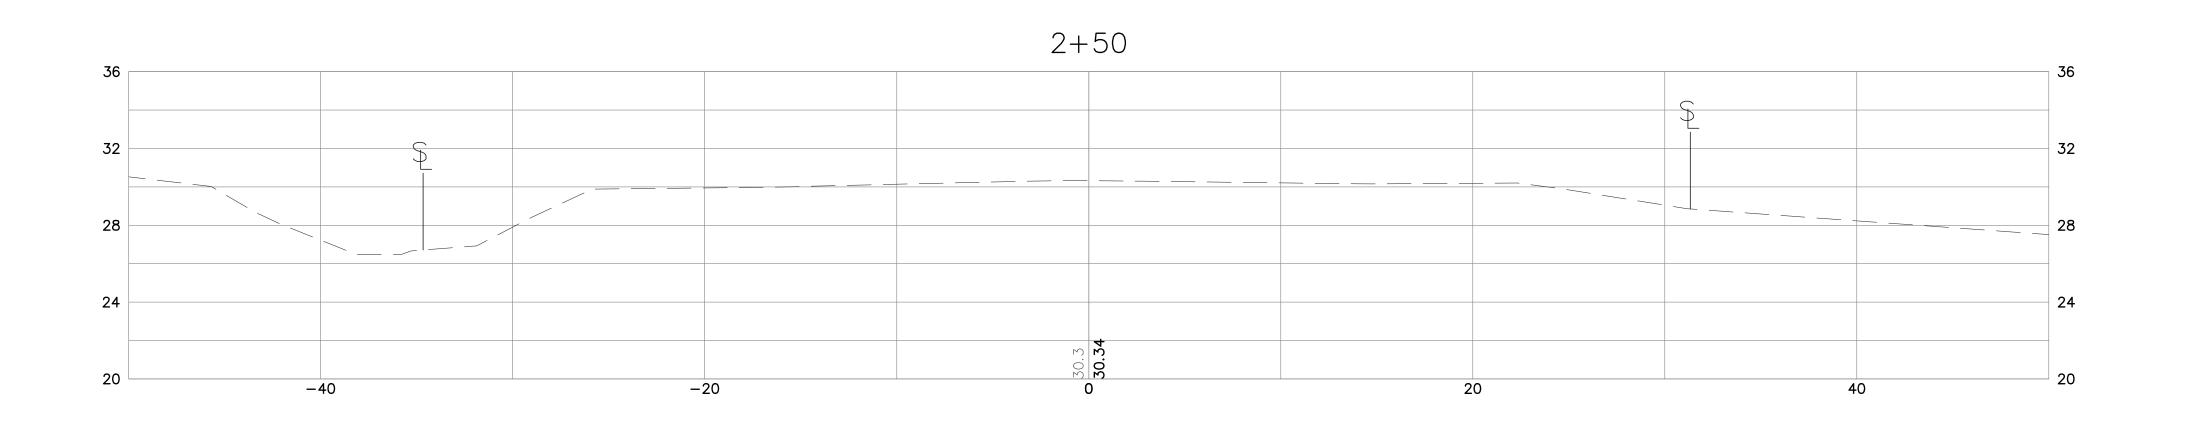

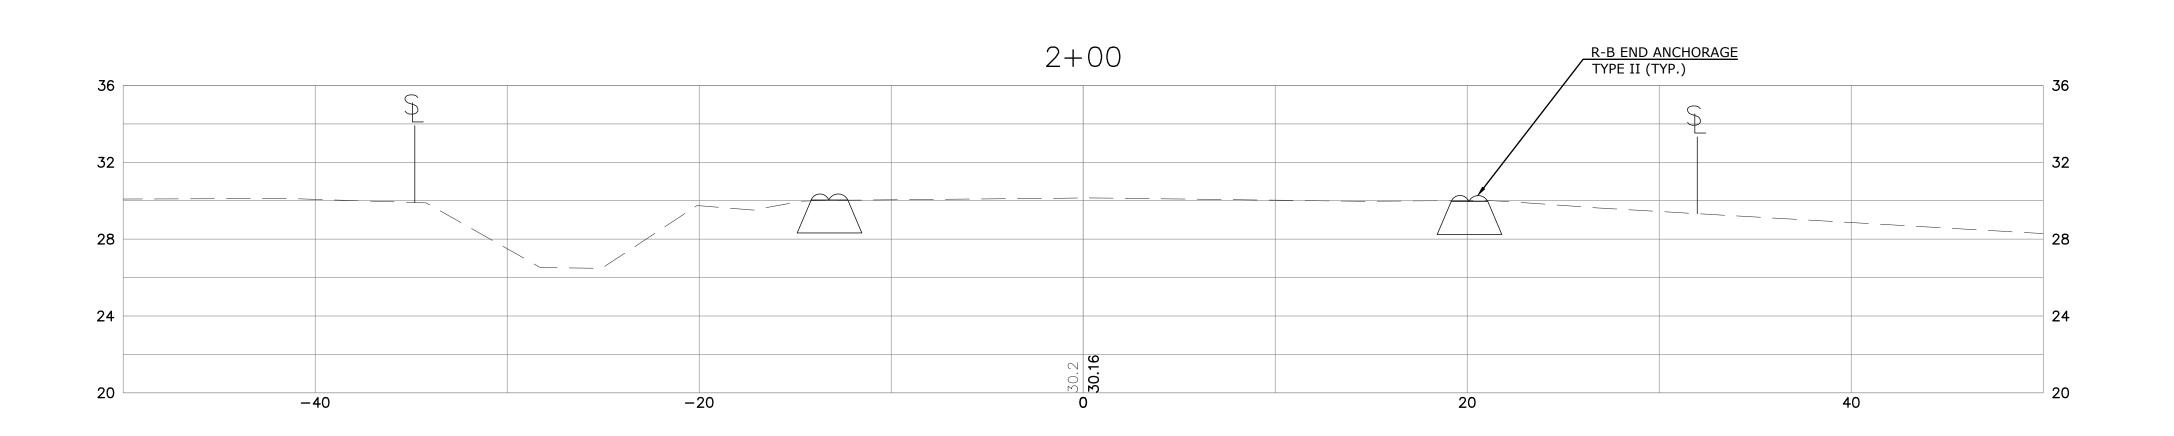

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SUPV.

		REVISIONS	DATE	11/19/2020	
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CONSULTING ENGINEERS

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PREPARED FOR


TOWN OF WALLINGFORD


45 SOUTH MAIN STREET


WALLINGFORD, CT 06492


REHABILITATION OF SOUTH TURNPIKE ROAD CULVERT OVER MANSION BROOK ROADWAY CROSS SECTION-2

						SHEET	7
D – s.	TURNPIKE ROAD		16032.10	_			
SIZE	PROJECT	FILE NAME	NUMBER		REV.	OF	15
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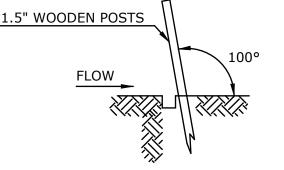


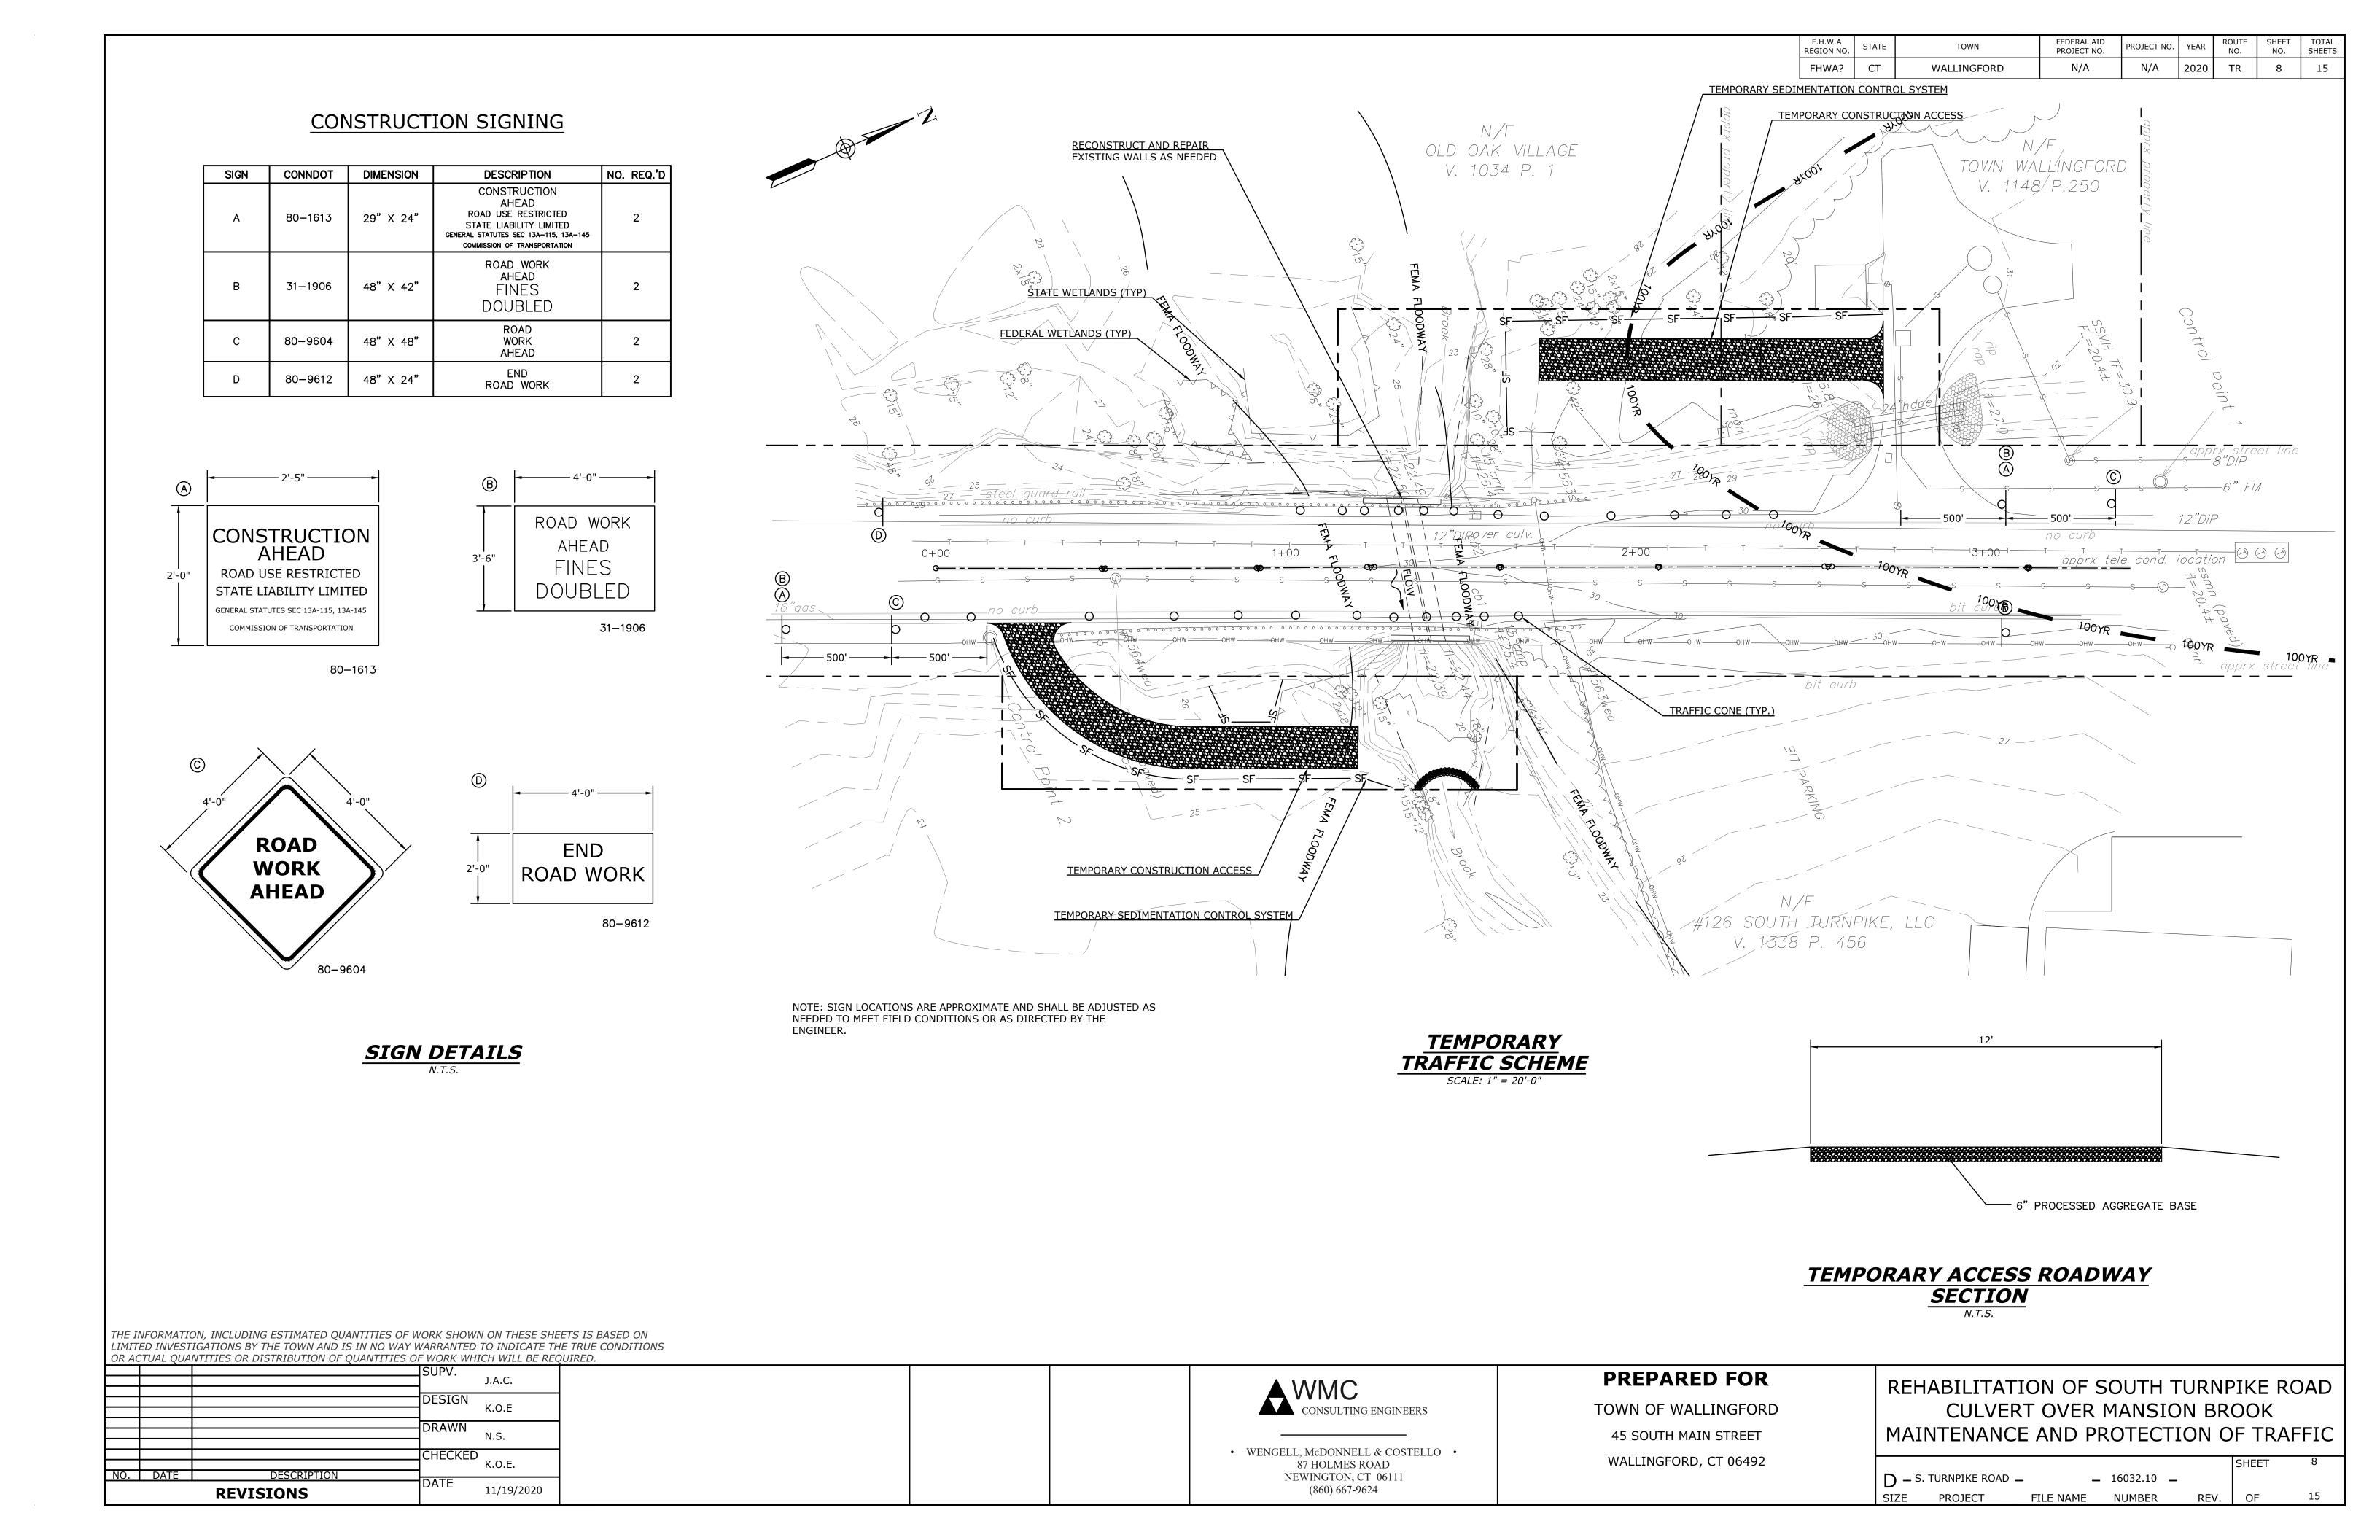

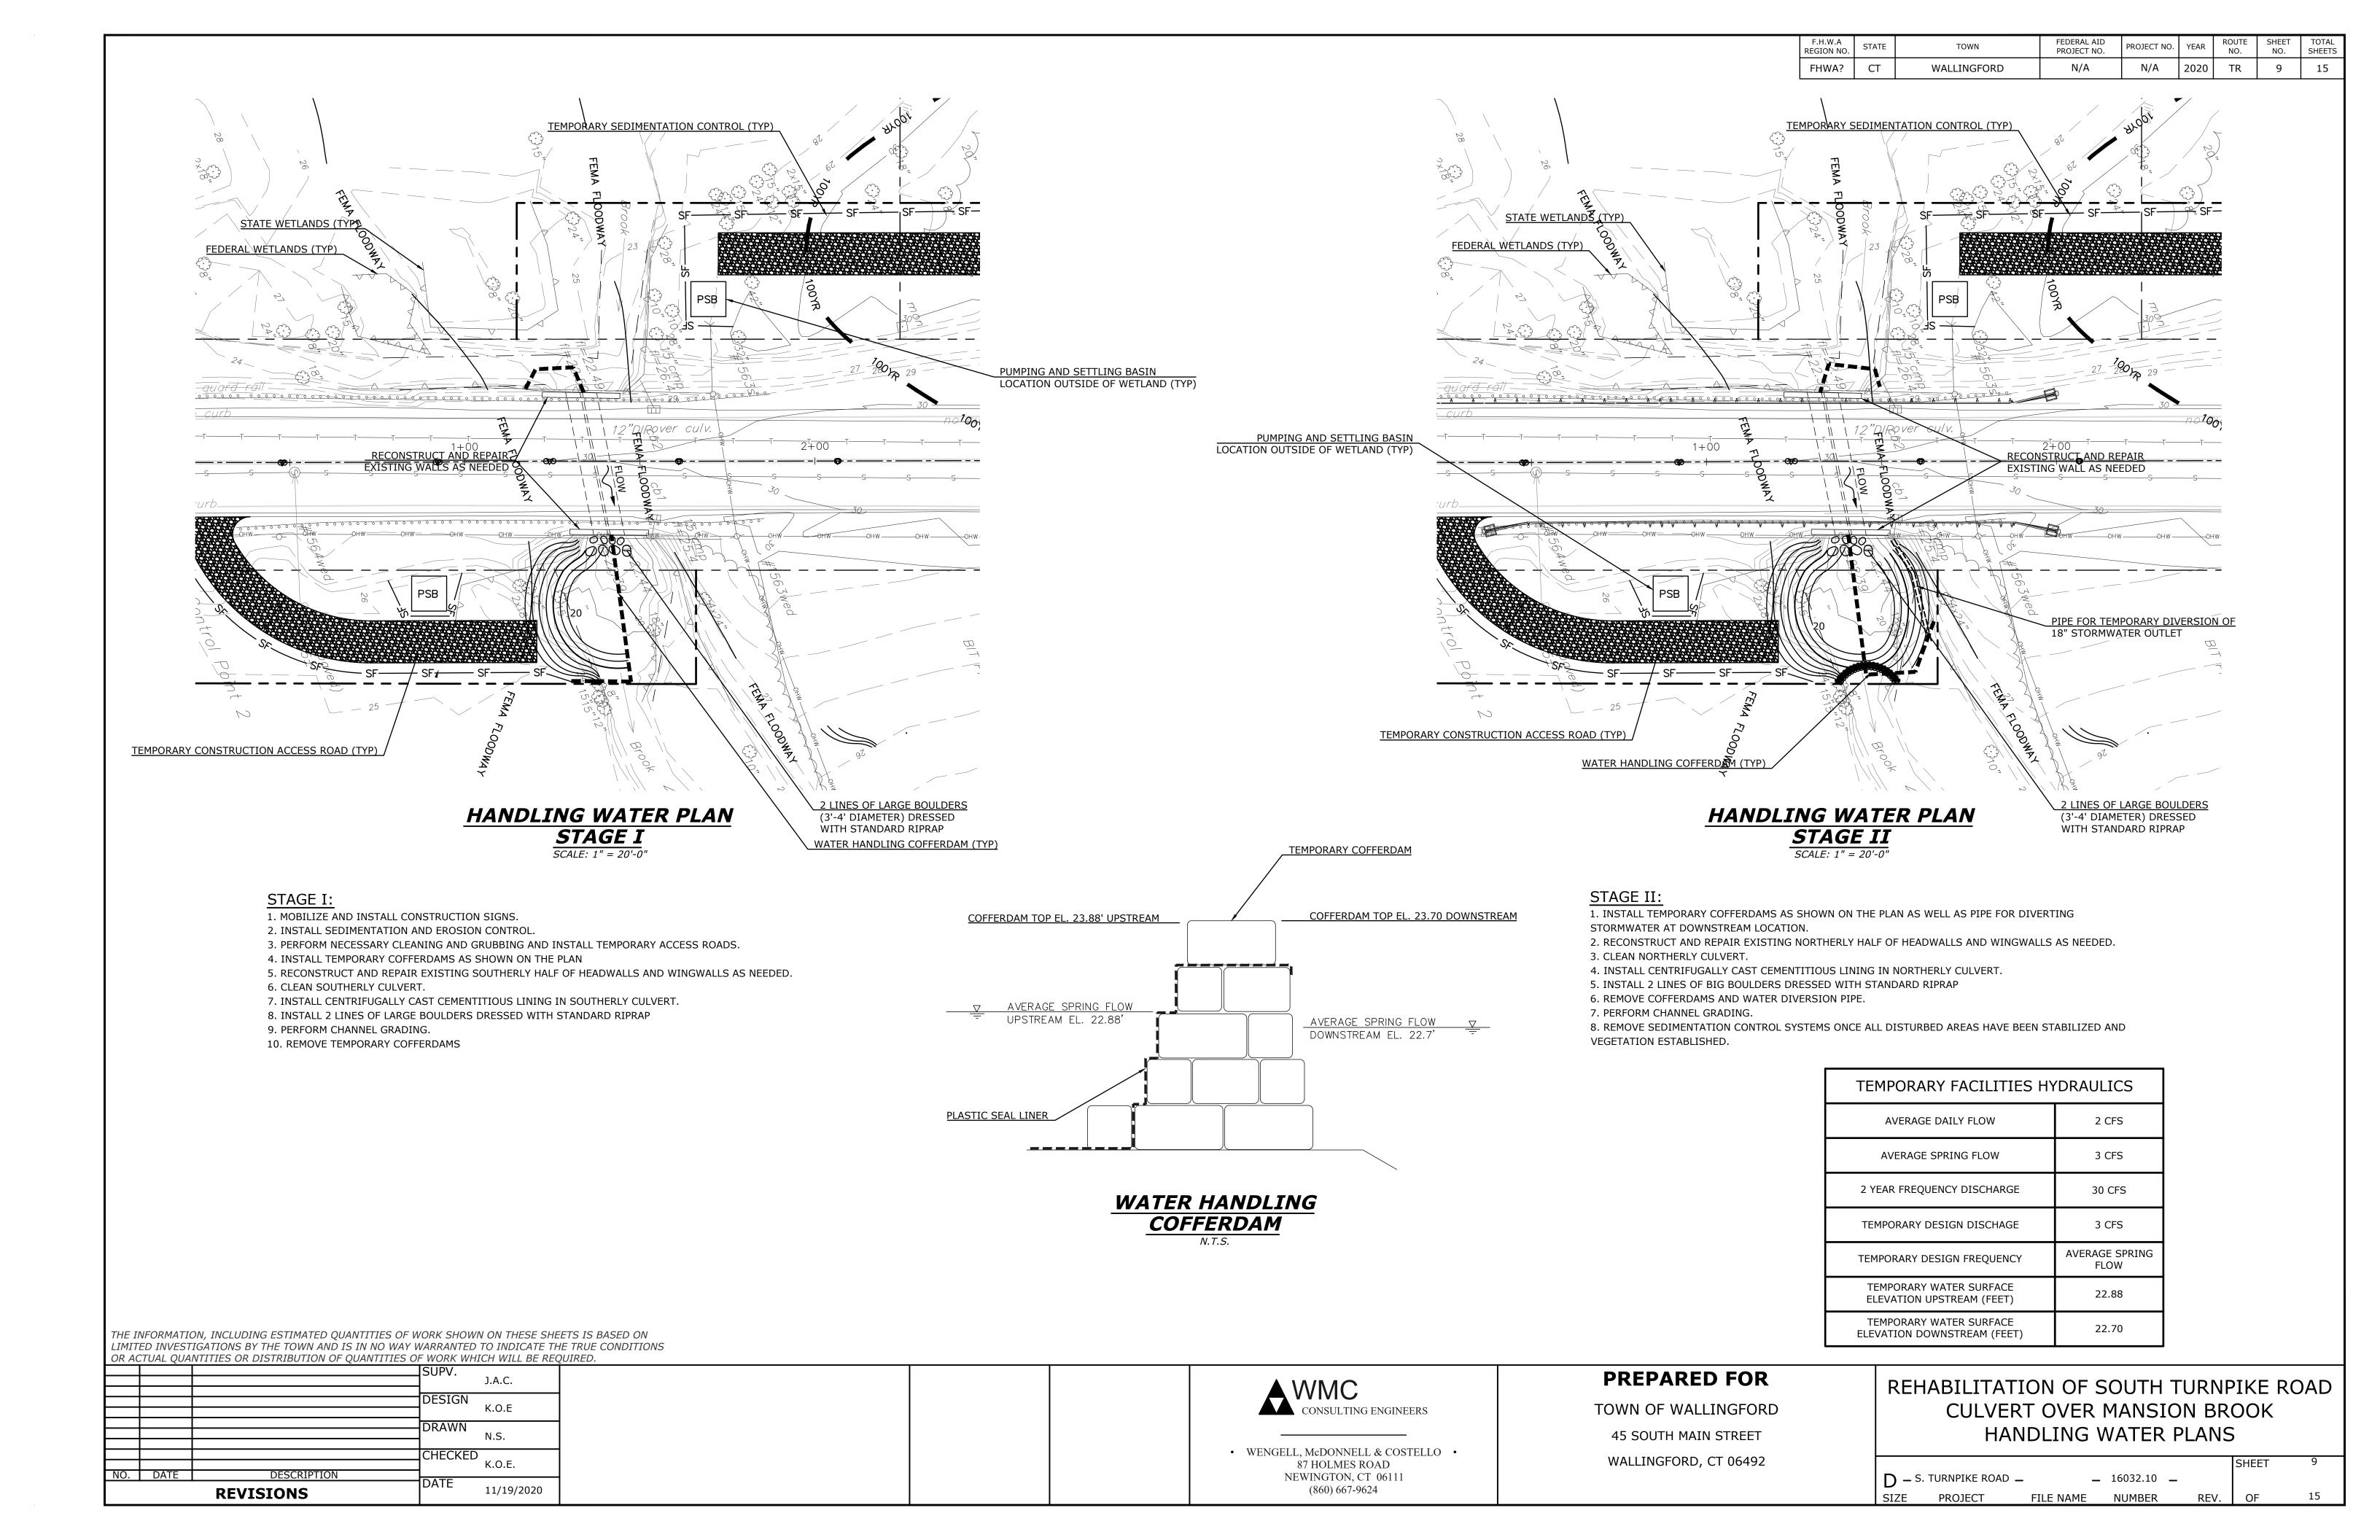

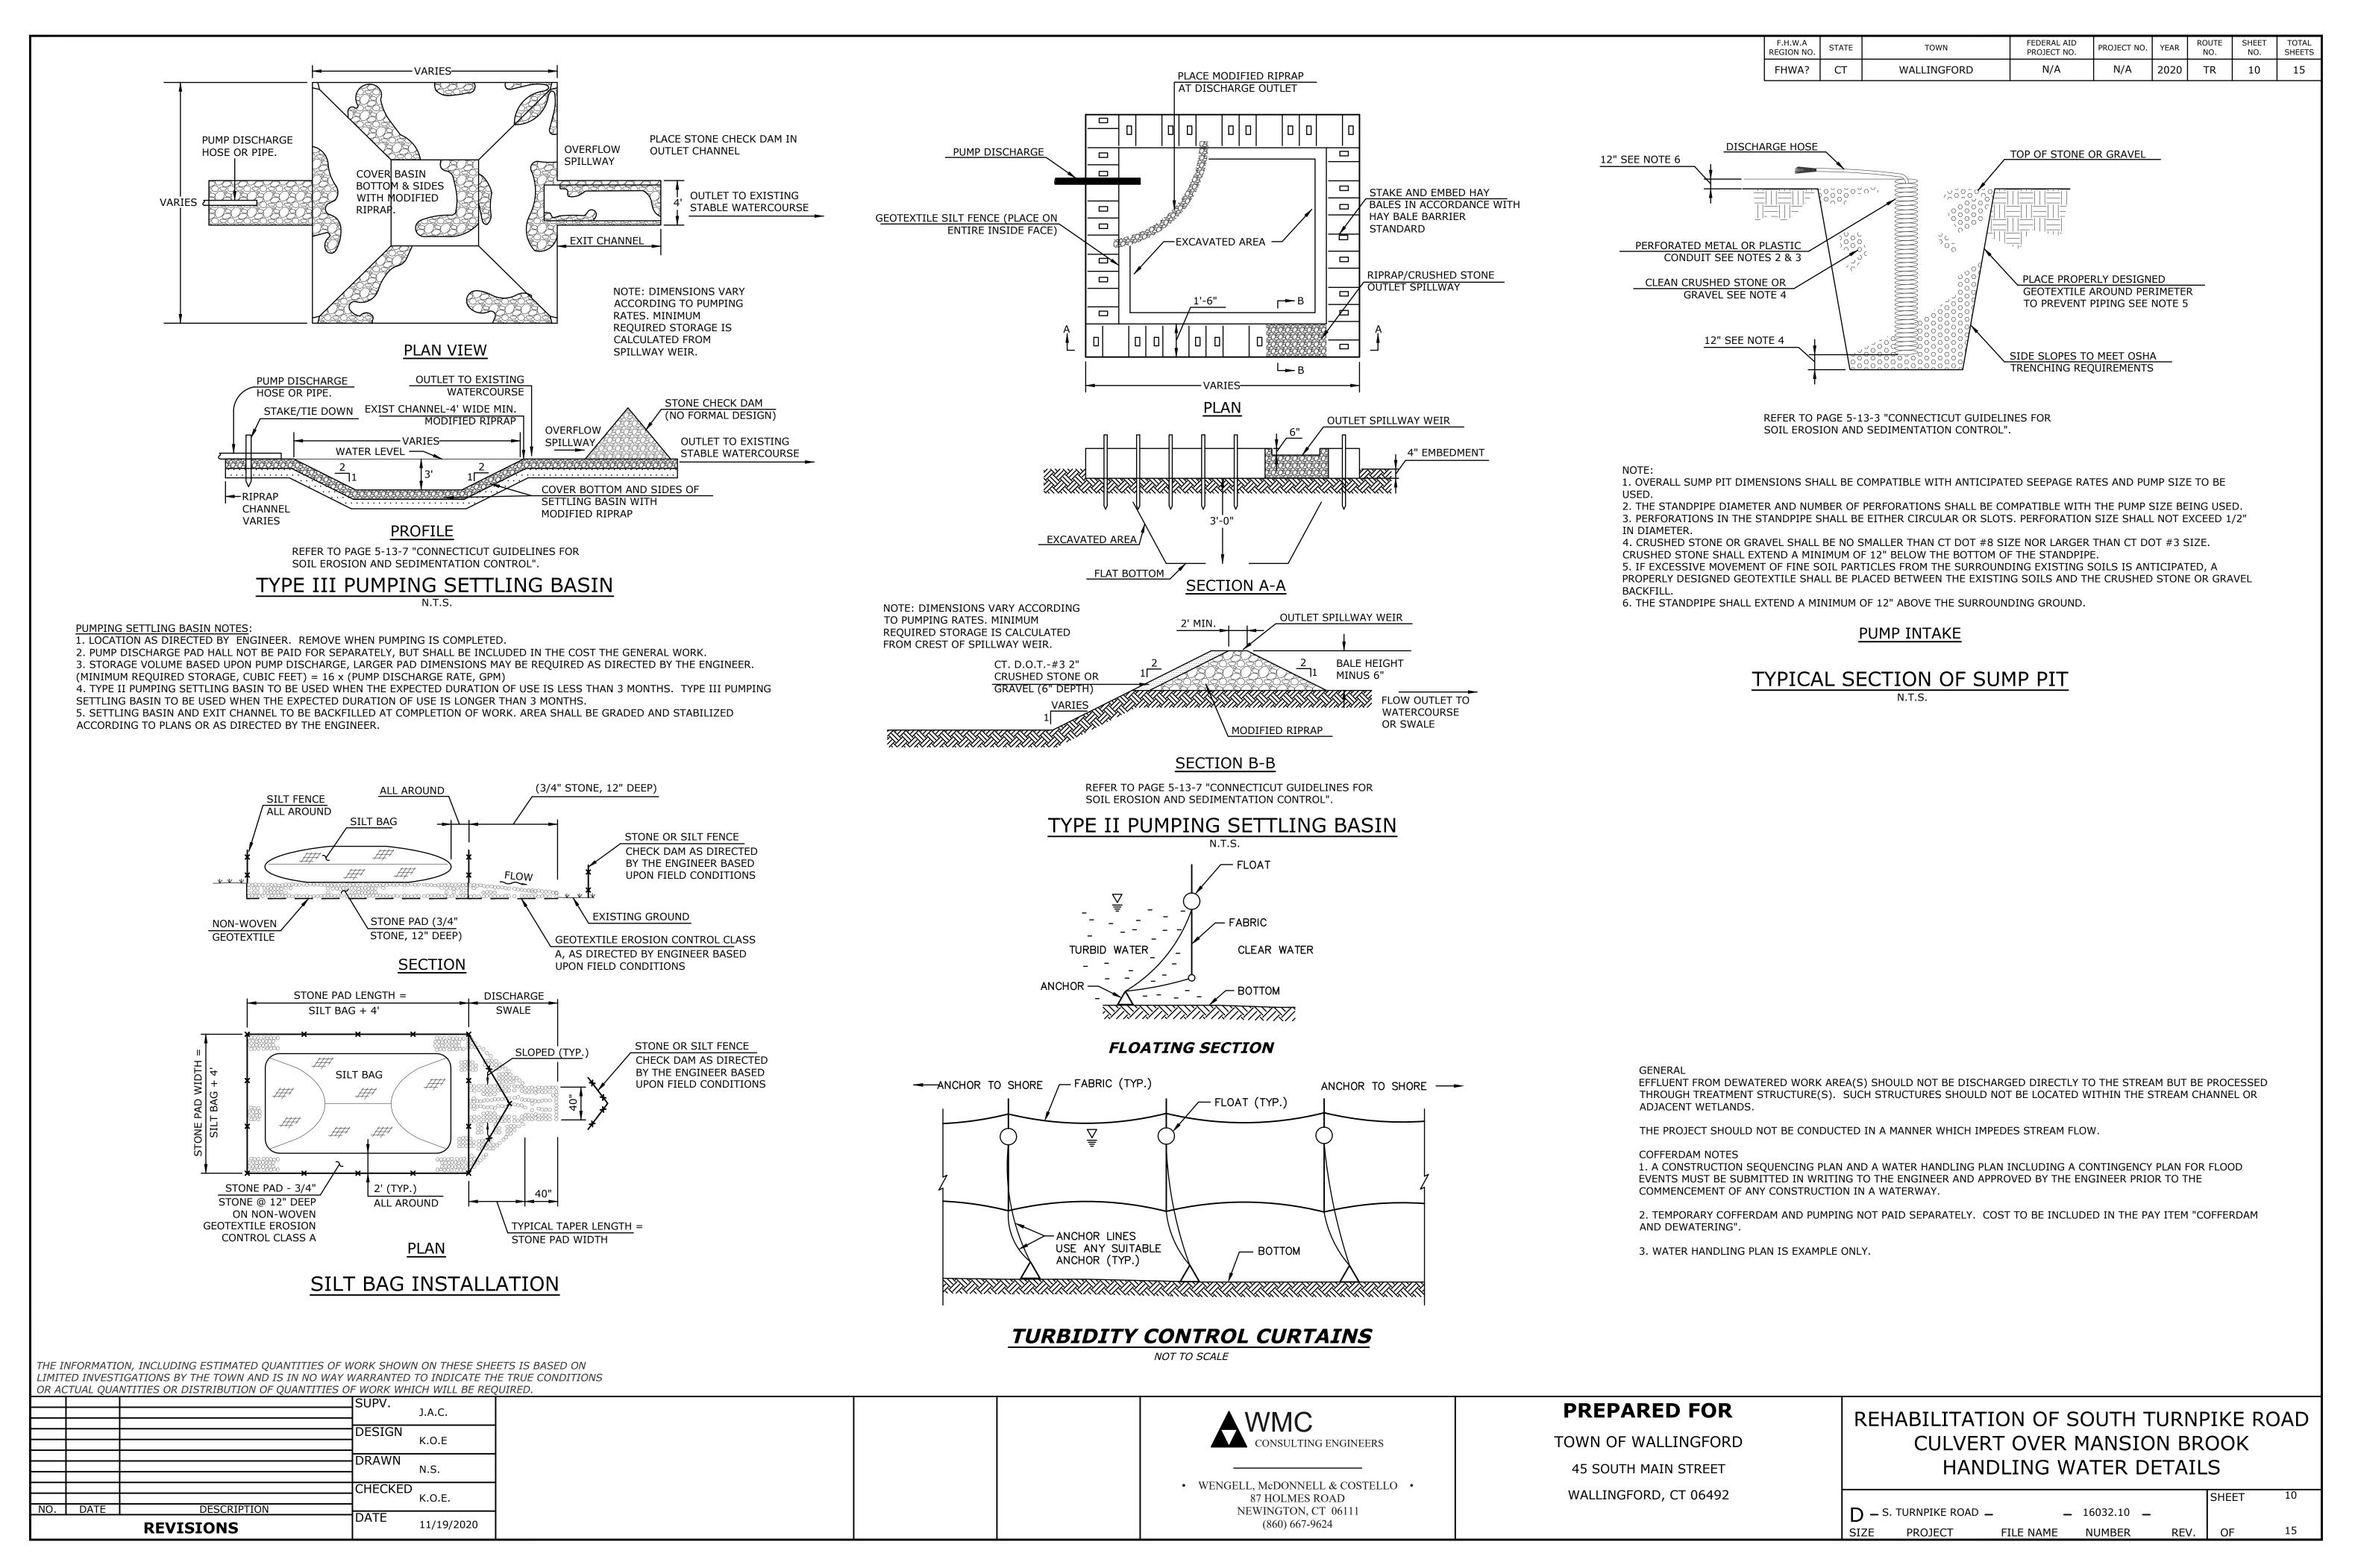

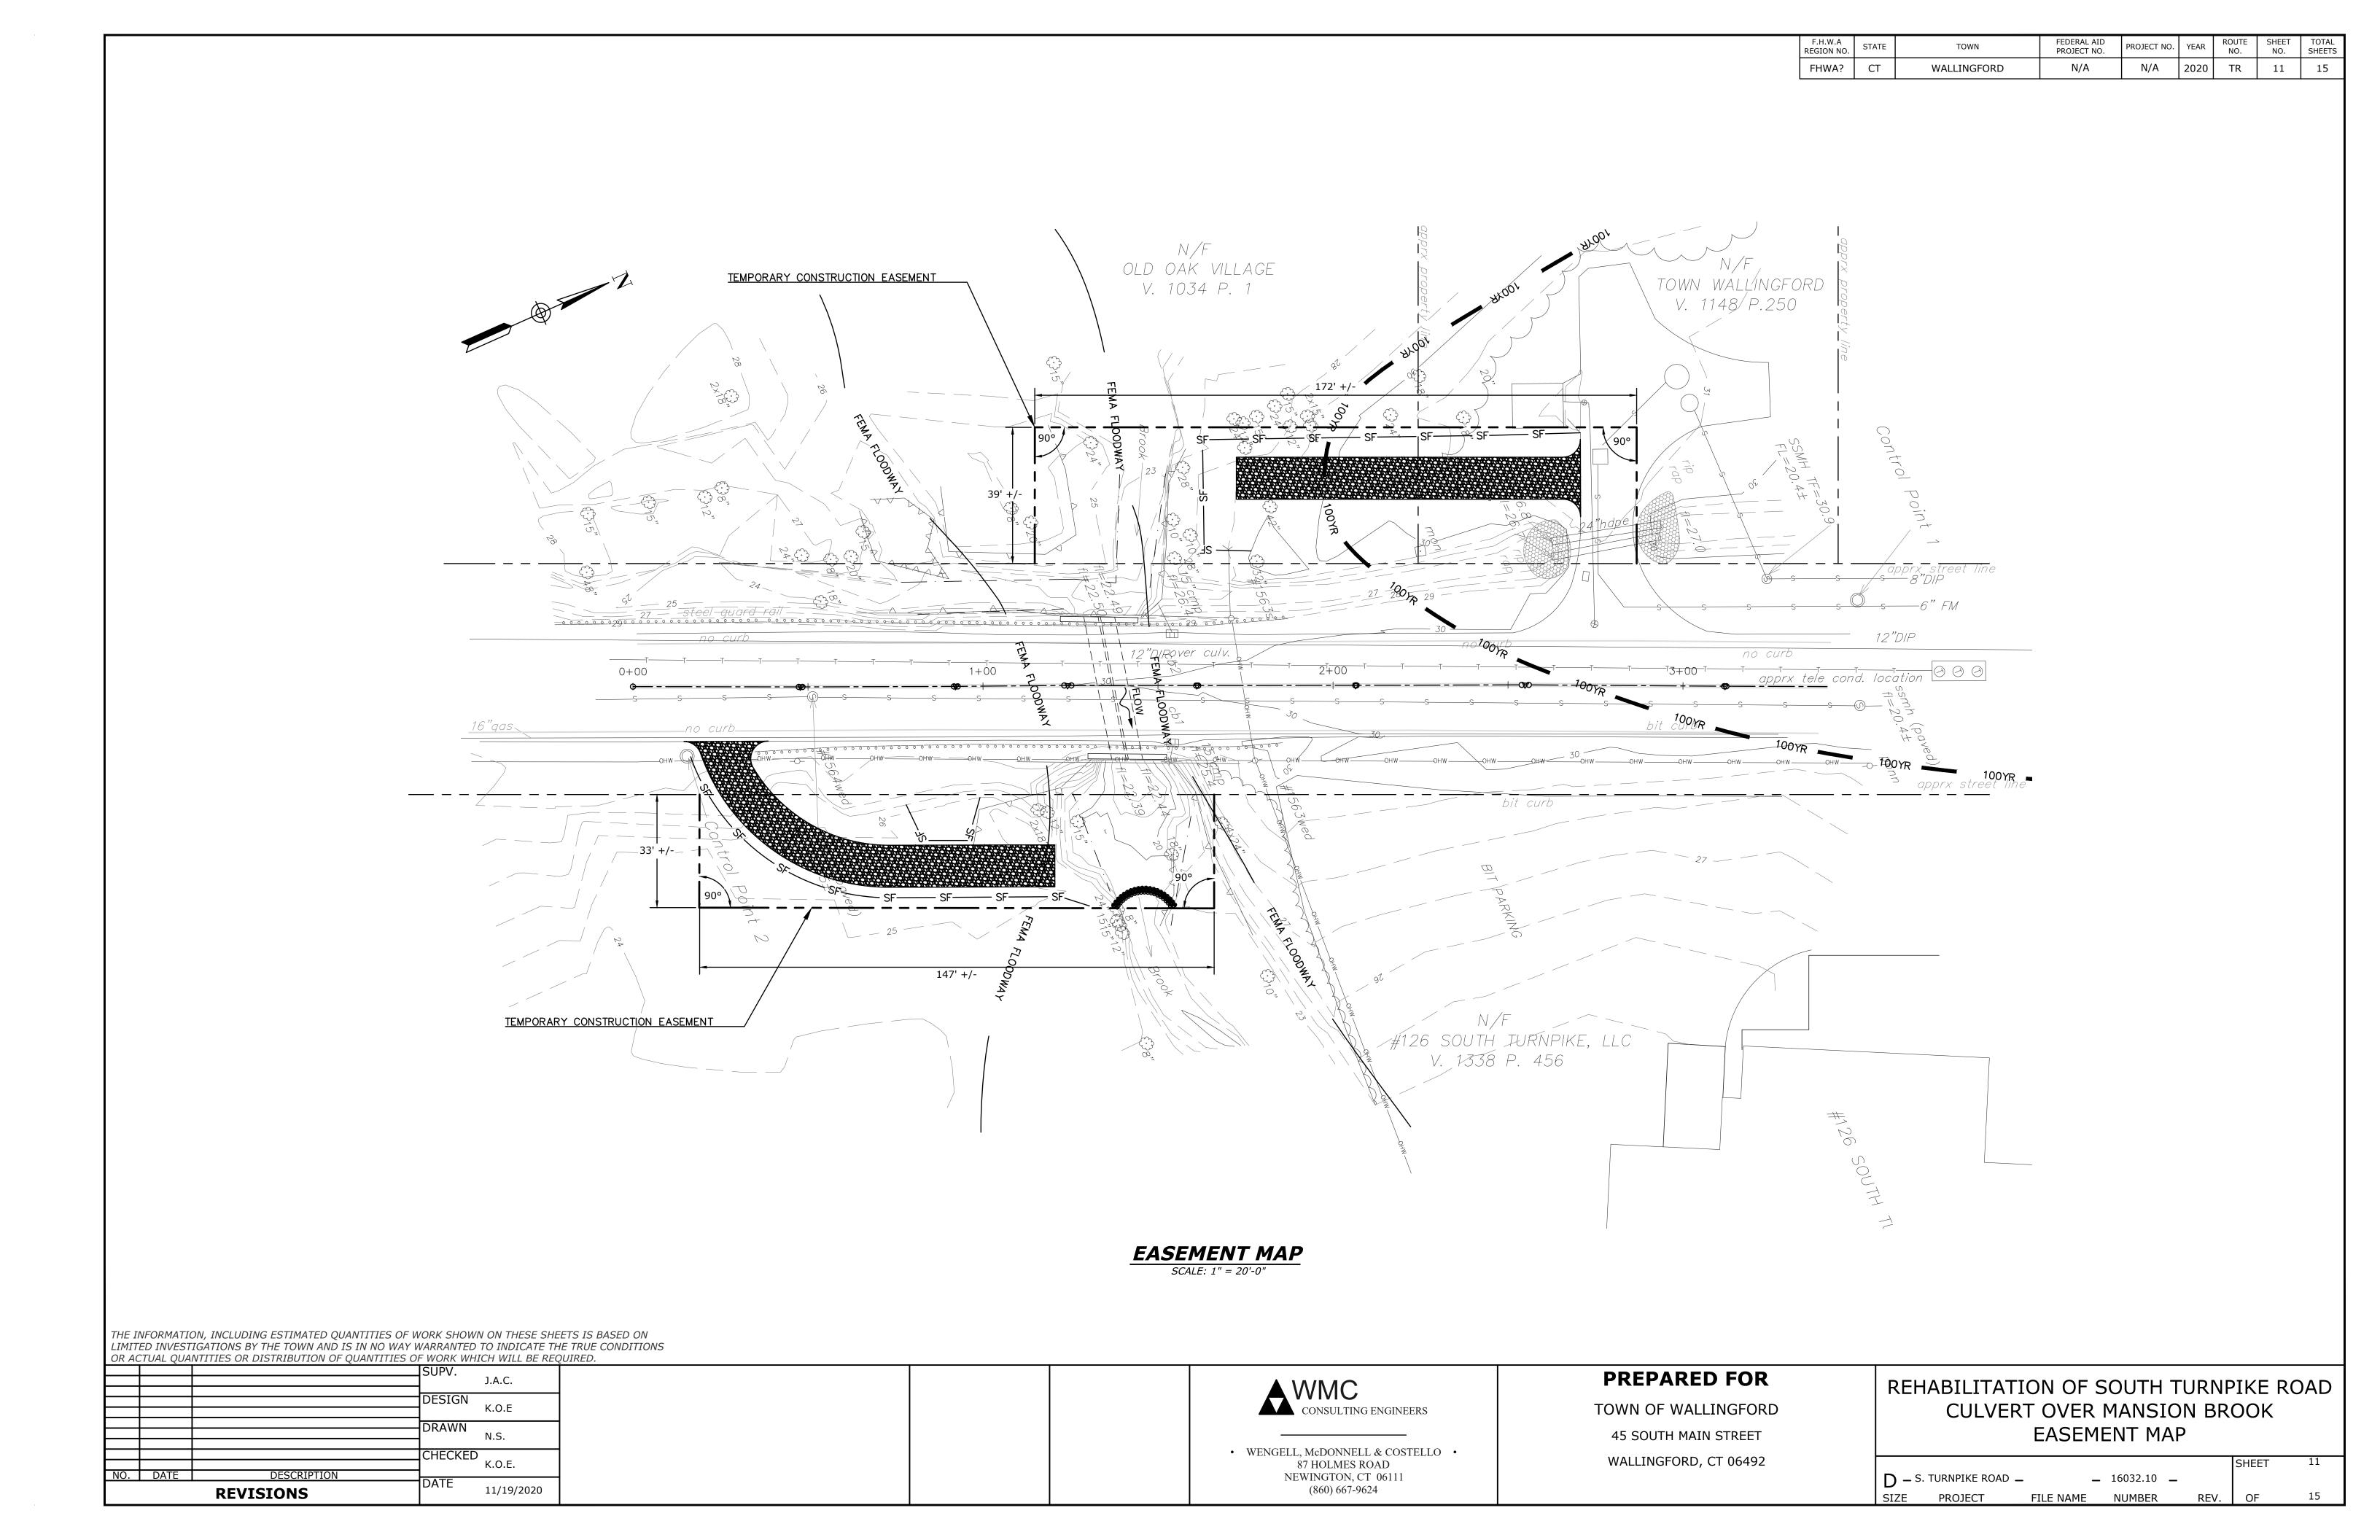YEAR NO. REGION NO. PROJECT NO. 2020 TR FHWA? WALLINGFORD 12



1. SET POSTS AND EXCAVATE A 6"x6" TRENCH. SET POSTS DOWN SLOPE. ANGLE 10° UPSLOPE FOR STABILITY AND SELF CLEANING

FLOW 3. ATTACH GEOTEXTILE TO 2. ATTACH THE WIRE MESH 4. BACKFILL THE TRENCH AND

IT TO THE TRENCH.

THE WIRE FENCING AND EXTEND


* WHEN INSTALLATION OF TRENCH IS IMPRACTICAL, ALTERNATE INSTALLATION SHALL BE TO LAY 6" FLAP HORIZONTALLY ON GROUND AND BURY FLAP BY RAMP SOIL OR STONE UP TO CONTROL FENCE. DEPTH OF RAMP SHALL BE AS REQUIRED TO HOLD DOWN FLAP WITHOUT LEAKAGE UNDER CONTROL FENCE WHILE MAINTAINING MINIMUM HEIGHT.

GEOTEXTILE FENCE SYSTEM

REFER TO PAGE 5-11-35 "CONNECTICUT GUIDELINES FOR SOIL EROSION AND SEDIMENTATION CONTROL" AND PAGE 55 "ON-SITE MITIGATION FOR CONSTRUCTION ACTIVITIES".

FENCING TO POST.

SEDIMENTATION CONTROL SYSTEM INSTALLATION

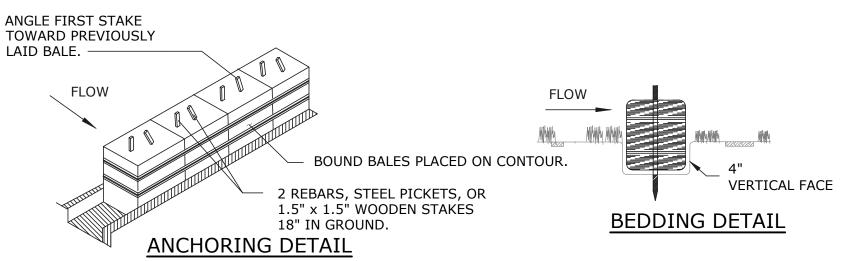


- HAY BALE CONSTRUCTION SPECIFICATIONS:
- 1. HAY BALES SHALL BE PLACED AROUND NEWLY INSTALLED CATCH BASINS IN SAGS AND DROP INLETS TO PREVENT SEDIMENTATION AND OTHER DEBRIS FROM ACCUMULATING ON THE GRATE OR IN THE SUMP. HAY BALES SHOULD BE KEPT CLEAN AND FREE OF DEBRIS TO FACILITATE FLOW.
- 2. EACH BALE SHALL BE EMBEDDED IN THE SOIL A MINIMUM OF 4", AND
- PLACED SO THE BINDINGS ARE HORIZONTAL 3. BALES SHALL BE SECURELY ANCHORED IN PLACE BY EITHER TWO STAKES OR REBARS DRIVEN THROUGH THE BALE. THE FIRST STAKE SHALL BE DRIVEN
- TOWARD THE PREVIOUSLY LAID BALE AT AN ANGLE TO FORCE THE BALES TOGETHER. STAKES SHALL BE DRIVEN FLUSH WITH THE BALE. 4. INSPECTION SHALL BE FREQUENT AND REPAIR REPLACEMENT SHALL BE MADE
- PROMPTLY AS NEEDED. 5. BALES SHALL BE REMOVED WHEN THEY HAVE SERVED THEIR USEFULNESS

SO AS NOT TO BLOCK OR IMPEDE STORM FLOW OR DRAINAGE.

REFER TO PAGE 5-11-30 "CONNECTICUT GUIDELINES FOR SOIL EROSION AND SEDIMENTATION CONTROL" AND PAGE 53 "ON-SITE MITIGATION FOR CONSTRUCTION ACTIVITIES".


HAY BALE DETAIL

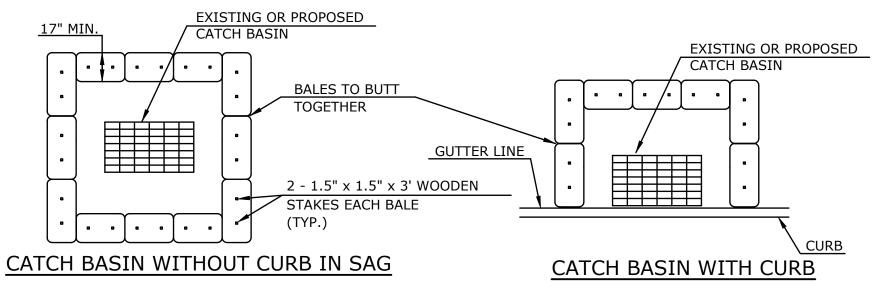

REFER TO PAGE 5-11-33 "CONNECTICUT GUIDELINES FOR SOIL EROSION AND SEDIMENTATION CONTROL" AND PAGE 40 "ON-SITE MITIGATION FOR CONSTRUCTION ACTIVITIES".

SEDIMENTATION CONTROL DETAILS

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THIS PLAN PROPOSES EROSION CONTROL MEASURES TO HELP CONTROL ACCELERATED EROSION AND SEDIMENTATION AND REDUCE THE DANGER FROM STORM WATER RUNOFF AT THE SITE. THE RUNOFF SHALL BE CONTROLLED BY THE INTERCEPTION, DIVERSION, AND SAFE DISPOSAL OF PRECIPITATION. RUNOFF SHALL ALSO BE CONTROLLED BY STAGING CONSTRUCTION ACTIVITY AND PRESERVING NATURAL VEGETATION WHENEVER POSSIBLE. EXISTING VEGETATION SHALL BE PROTECTED AND ONLY THAT CLEARING AND GRUBBING ABSOLUTELY NECESSARY FOR THE PROPOSED CONSTRUCTION SHALL BE PERFORMED. ALL DISTURBED AREAS SHALL BE RESTORED TO THEIR ORIGINAL CONDITION AND CONTOUR, UNLESS OTHERWISE INDICATED ON THE PLANS. THE CONTRACTOR SHALL TAKE SPECIAL CARE WITH HIS CONSTRUCTION METHODS AND SHALL COMPLY WITH THE FOLLOWING GUIDELINES. REFERENCE IS MADE TO THE "CONNECTICUT GUIDELINES FOR SOIL EROSION AND SEDIMENTATION CONTROL" (2002), AS AMENDED. THE GUIDELINES ARE OBTAINABLE FROM THE CONNECTICUT DEPARTMENT OF ENERGY AND ENVIRONMENTAL PROTECTION, 79 ELM STREET, HARTFORD, CONNECTICUT 06106, AND SHOULD BE USED AS A REFERENCE IN CONSTRUCTING THE EROSION AND SEDIMENTATION CONTROLS INDICATED ON THESE PLANS. AN ADDITIONAL REFERENCE IS THE 1994 CONNDOT PUBLICATION "ON-SITE MITIGATION FOR CONSTRUCTION ACTIVITIES". REFER TO PAGE 5-12-2 "CONNECTICUT GUIDELINES FOR SOIL EROSION AND SEDIMENTATION

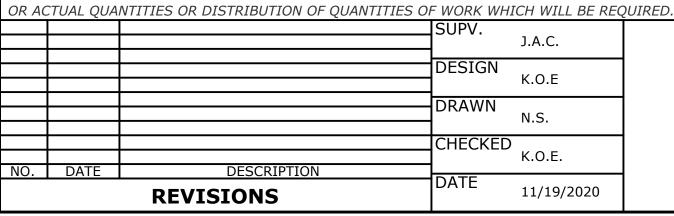← MOUNTABLE BERM

EXISTING

PAVEMENT

(OPTIONAL)

GEOTEXTILE (SEPARATION-

GROUND

CONSTRUCTION SPECIFICATION:

MINIMUM LENGTH WOULD APPLY).

REMOVED IMMEDIATELY.

3. THICKNESS - NOT LESS THAN 6".

REQUIRED ON A SINGLE FAMILY RESIDENCE LOT.

COMPACT THE EXCAVATED SOIL

HIGH SURVIVABILITY)

1. STONE SIZE - USE 2" STONE, OR RECLAIMED OR RECYCLED CONCRETE EQUIVALENT.

PLAN VIEW

2. LENGTH - AS REQUIRED, BUT NOT LESS THAN 50 FT (EXCEPT ON A SINGLE RESIDENCE LOT WHERE A 30'

PIPED ACROSS THE ENTRANCE. IF PIPING IS IMPRACTICAL, A MOUNTABLE BERM WITH 5:1 SLOPES WILL BE

FLOWING OF SEDIMENT ONTO PUBLIC RIGHT-OF-WAYS. THIS MAY REQUIRE PERIODIC TOP DRESSING WITH

8. WASHING - WHEELS SHALL BE CLEANED TO REMOVE SEDIMENT PRIOR TO ENTRANCE ONTO PUBLIC

9. PERIODIC INSPECTION AND NECESSARY MAINTENANCE SHALL BE PROVIDED AFTER EACH RAINFALL. 10. THE COST OF CONSTRUCTING THE STABILIZED CONSTRUCTION ENTRANCE WILL NOT BE PAID FOR

SEPARATELY, BUT SHALL BE INCLUDED IN THE COST OF THE GENERAL WORK.

7. MAINTENANCE - THE ENTRANCE SHALL BE MAINTAINED IN A CONDITION WHICH WILL PREVENT TRACKING OR

SEDIMENT. ALL SEDIMENT SPILLED, DROPPED, WASHED OR TRACKED ONTO PUBLIC RIGHT-OF-WAYS MUST BE

RIGHT-OF-WAY. WHEN WASHING IS REQUIRED, IT SHALL BE DONE ON AN AREA STABILIZED WITH STONE AND

STABILIZED CONSTRUCTION ENTRANCE

WHICH DRAINS INTO AN APPROVED SETTLING AREA SIZED TO HOLD THE VOLUME OF WATER USED DURING ANY

ADDITIONAL STONE AS CONDITIONS DEMAND AND REPAIR AND/OR CLEANOUT OF ANY MEASURES USED TO TRAP

4. WIDTH - 12' MINIMUM, BUT NOT LESS THAN THE FULL WIDTH AT POINTS WHERE INGRESS OR EGRESS OCCURS.

5. GEOTEXTILE - WILL BE PLACED OVER THE ENTIRE AREA PRIOR TO PLACING OF STONE. GEOTEXTILE WILL NOT BE

CONTROL" AND PAGE 50 "ON-SITE MITIGATION FOR CONSTRUCTION ACTIVITIES".

ALL AREAS SHALL BE PROTECTED FROM EROSION DURING AND AFTER CONSTRUCTION, PARTICULARLY THE STORAGE OF EXCAVATED OR STOCKPILED MATERIAL. THE CONTRACTOR SHALL CAREFULLY STRIP ALL TOPSOIL, LOAM, OR ORGANIC MATTER PRIOR TO TRENCHING OR OTHER OPERATIONS AND SHALL STORE THEM SEPARATELY FROM ALL OTHER MATERIALS DURING EXCAVATION. EACH STOCKPILE MUST BE ADEQUATELY RINGED WITH SEDIMENTATION CONTROL SYSTEM (I.E. HAY BALES AND/OR GEOTEXTILE FENCE). DEBRIS AND OTHER WASTE RESULTING FROM EQUIPMENT MAINTENANCE AND CONSTRUCTION WILL NOT BE DISCARDED ON SITE. STABILIZING OF SLOPES SHALL BE DONE IMMEDIATELY AFTER CONSTRUCTION OF SLOPES. SLOPES STEEPER THAN 4:1 SHALL BE PROTECTED WITH EROSION CONTROL MATTING. THIS MATTING IS MANUFACTURED COMBINATIONS OF MULCH AND NETTING AND SHALL BE INSTALLED IN ACCORDANCE WITH THE MANUFACTURER'S RECOMMENDATIONS. ALL OTHER AREAS SHALL BE MULCHED WITH HAY OR STRAW AT A RATE OF 2 TO 3 TONS PER ACRE. STRAW OR HAY MULCH MUST BE ANCHORED IMMEDIATELY AFTER SPREADING TO PREVENT WINDBLOWING. THE METHODS RECOMMENDED BY THE "CONNECTICUT GUIDELINES FOR SOIL EROSION AND SEDIMENTATION CONTROL" SHALL BE USED FOR THE ANCHORING OF MULCH OR NETTING.

6. SURFACE WATER - ALL SURFACE WATER FLOWING OR DIVERTED TOWARD CONSTRUCTION ENTRANCES SHALL BE EROSION AND SEDIMENTATION CONTROL PLAN

AN EROSION AND SEDIMENTATION CONTROL PLAN MUST BE SUBMITTED IN WRITING TO THE ENGINEER AND APPROVED BY THE ENGINEER PRIOR TO THE COMMENCEMENT OF ANY CONSTRUCTION ACTIVITIES.

SEDIMENTATION CONTROL SYSTEM - THE SEDIMENTATION CONTROL SYSTEM SHALL CONSIST OF A GEOTEXTILE BARRIER FENCE. THE SEDIMENTATION CONTROL SYSTEM SHALL BE INSTALLED IMMEDIATELY AFTER A CUT SLOPE HAS BEEN GRADED, BEFORE A FILL SLOPE HAS BEEN CREATED AND AS INDICATED ON THE PLANS. THE SYSTEM IS DESIGNED TO INTERCEPT SILT AND SEDIMENT BEFORE IT REACHES THE WETLANDS OR WATERCOURSES. DEPOSITS OF SEDIMENT AND SILT ARE TO BE PERIODICALLY REMOVED FROM THE UPSTREAM SIDE OF THE FENCE. THIS MATERIAL IS TO BE SPREAD AND STABILIZED IN AREAS NOT SUBJECT TO EROSION, OR IN AREAS WHICH ARE NOT TO BE PAVED OR BUILT ON. THE SEDIMENTATION CONTROL SYSTEM IS TO BE REPLACED AS NECESSARY TO PROVIDE PROPER FILTERING ACTION. THE SYSTEM IS TO REMAIN IN PLACE AND BE MAINTAINED TO INSURE EFFICIENT SILTATION CONTROL UNTIL ALL AREAS ABOVE THE FENCE ARE STABILIZED AND VEGETATION HAS BEEN ESTABLISHED.

STACKED HAY BALES - HAY OR STRAW BALES USED FOR EROSION CONTROL SHALL BE STACKED AT CATCH BASINS WHERE SEDIMENT MAY ENTER THE CATCH BASIN OR AS DIRECTED BY THE RESIDENT ENGINEER. DEPOSITS OF SEDIMENT AND SILT ARE TO BE PERIODICALLY REMOVED FROM THE UPSTREAM SIDE OF THE EROSION CHECKS. THIS MATERIAL IS TO BE SPREAD AND STABILIZED IN AREAS NOT SUBJECT TO EROSION, OR IN AREAS WHICH ARE NOT TO BE PAVED OR BUILT ON. HAY OR STRAW BALES ARE TO BE REPLACED AS NECESSARY TO PROVIDE PROPER FILTERING ACTION. THE SYSTEM IS TO REMAIN IN PLACE AND BE MAINTAINED TO INSURE EFFICIENT SILTATION CONTROL UNTIL ALL AREAS ABOVE THE EROSION CHECKS ARE STABILIZED AND VEGETATION HAS BEEN ESTABLISHED.

IN ALL AREAS, REMOVAL OF TREES, BUSHES, AND OTHER VEGETATION, AND DISTURBANCE OF THE SOIL, IS TO BE KEPT TO AN ABSOLUTE MINIMUM WHILE ALLOWING PROPER DEVELOPMENT OF THE SITE.

DURING CONSTRUCTION, AS SMALL AN AREA OF SOIL AS POSSIBLE SHOULD BE EXPOSED FOR AS SHORT A TIME AS POSSIBLE. AFTER CONSTRUCTION, GRADE, RESPREAD TOPSOIL, AND STABILIZE SOIL BY SEEDING AND MULCHING AS TO PREVENT EROSION.

EROSION AND SEDIMENTATION CONTROL MAINTENANCE PROCEDURES

ALL EROSION AND SEDIMENTATION CONTROL DEVICES SHALL BE INSPECTED DURING CONSTRUCTION ON A DAILY BASIS AND FOLLOWING ALL STORMS BY THE RESIDENT ENGINEER. THE CONTRACTOR SHALL MAINTAIN AND MAKE REPAIRS AND REMOVE SEDIMENT AS REQUESTED BY THE RESIDENT ENGINEER. THIS WORK SHALL BE PERFORMED WITHIN 24 HOURS OF THE REQUEST AND THERE SHALL BE NO SEPARATE PAYMENT FOR THIS WORK.

THE CONTRACTOR SHALL CLEAN SEDIMENT AND DEBRIS FROM ALL DRAINAGE STRUCTURES, AND PIPES AT THE COMPLETION OF CONSTRUCTION, AND AS REQUESTED BY THE RESIDENT INSPECTOR TO KEEP THE SYSTEM FUNCTIONING PROPERLY DURING CONSTRUCTION.

FOLLOWING COMPLETION OF CONSTRUCTION, THE CONTRACTOR SHALL REPAIR ALL ERODED AREAS AND ENSURE A GOOD STAND OF TURF IS ESTABLISHED THROUGHOUT. THE CONTRACTOR SHALL REPAIR ALL ERODED OR DISPLACED RIPRAP, AND CLEAN SEDIMENT COVERED STONES.

ALL APPROPRIATE EROSION AND SEDIMENT CONTROL MEASURES SHOULD BE ESTABLISHED PRIOR TO AND BE MAINTAINED THROUGH ALL CONSTRUCTION PHASES.


TOWN OF WALLINGFORD 45 SOUTH MAIN STREET


PREPARED FOR

WALLINGFORD, CT 06492

REHABILITATION OF SOUTH TURNPIKE ROAD CULVERT OVER MANSION BROOK **EROSION AND SEDIMENTATION CONTROL** DETAILS

						SHEET	12
D – s.	TURNPIKE ROAD _	_	16032.10	_			
SIZE	PROJECT	FILE NAME	NUMBER		REV.	OF	15

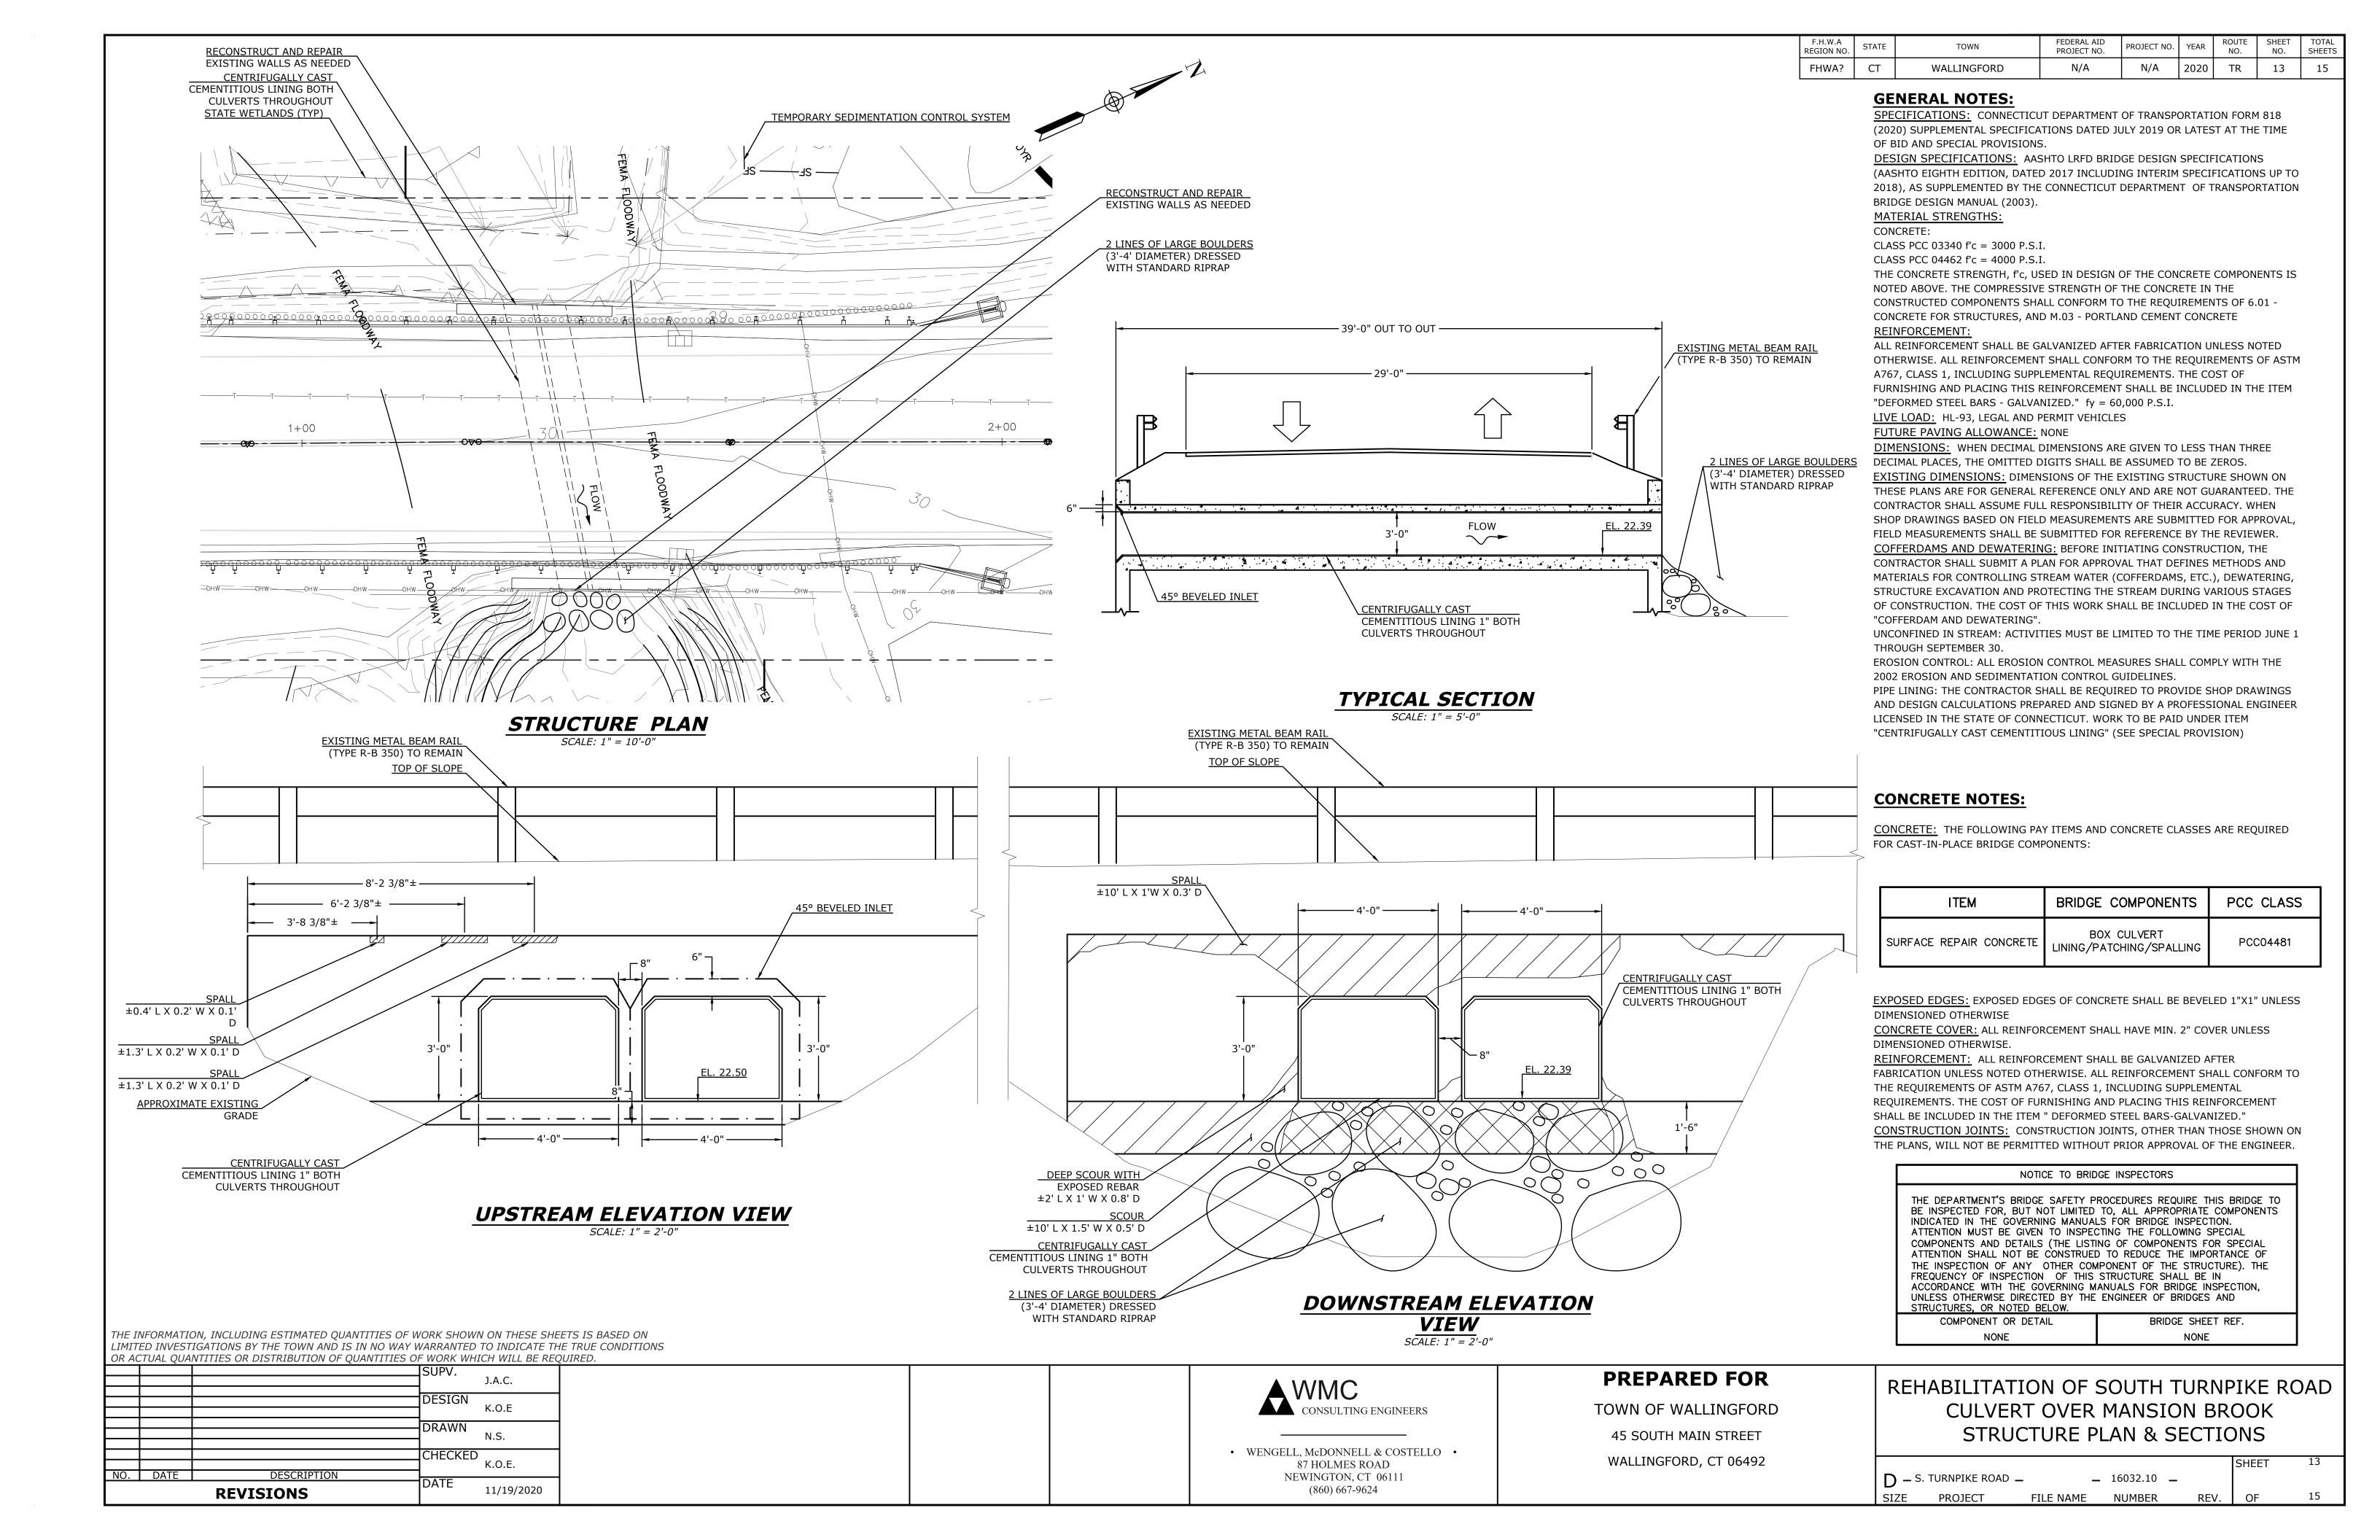

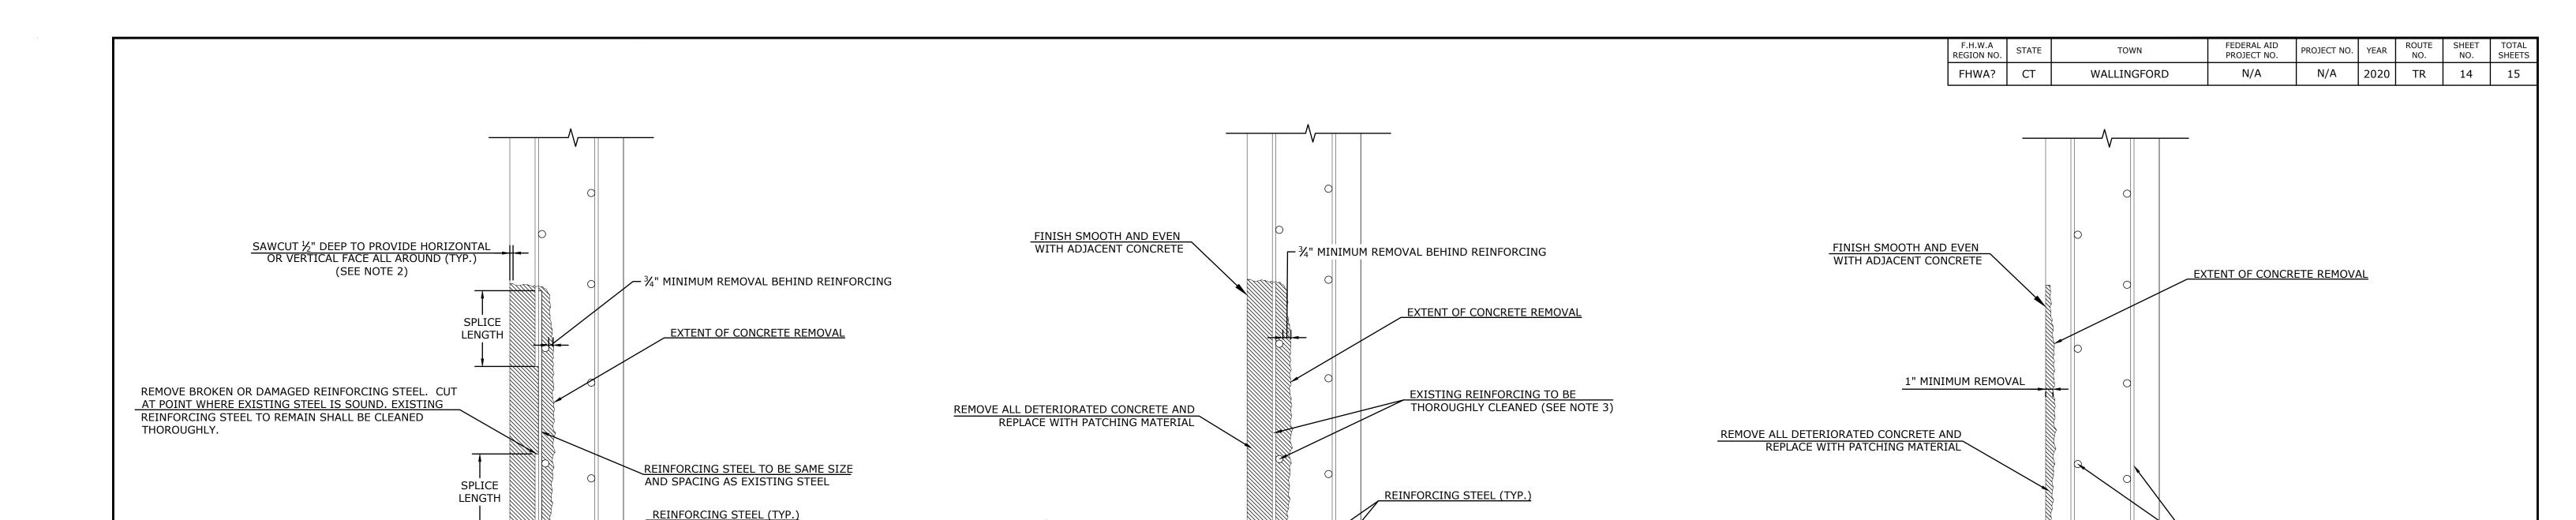

REPAIR OF DAMAGED REINFORCING STEEL

TYPICAL PARTIAL DEPTH PATCH REPAIR
(BELOW TOP REINFORCING STEEL)

NOT TO SCALE

SAWCUT ½" DEEP TO PROVIDE HORIZONTAL OR VERTICAL FACE ALL AROUND (TYP.)

(SEE NOTE 2)

PARTIAL DEPTH PATCH
(ABOVE TOP REINFORCING STEEL)

NOT TO SCALE

CONCRETE REPAIR NOTES:

SAWCUT ½" DEEP TO PROVIDE HORIZONTAL OR VERTICAL FACE ALL AROUND (TYP.)

(SEE NOTE 2)

1. THE DETERIORATED AREAS SHALL BE REPAIRED BY THE CONTRACTOR UTILIZING THE "PARTIAL DEPTH PATCH" ITEM FOR REPAIR TO THE WALLS AS DIRECTED BY THE ENGINEER.

REINFORCING STEEL (TYP.)

- 2. THE COST OF REMOVAL OF THE DETERIORATED CONCRETE, INCLUDING THE 1/2 IN. SAW CUT, AND THE FURNISHING AND PLACING THE CONCRETE SHALL BE PAID FOR UNDER THE ITEM "PARTIAL DEPTH PATCH" FOR REPAIR TO THE WALLS.
- 3. WHERE EXISTING REINFORCING STEEL IS NOT SOUND, REPAIRS SHALL BE MADE AS SHOWN ON THIS SHEET AND/OR AS DIRECTED BY THE ENGINEER.
- 4. THE REINFORCEMENT USED FOR REPAIRS SHALL CONFORM TO ASTM A615 GRADE 60.
- 5. THE COST OF FURNISHING AND PLACING THE REINFORCEMENT SHALL BE PAID FOR UNDER THE ITEM "DEFORMED STEEL BARS".
- 6. CONCRETE USED FOR PARTIAL DEPTH PATCH SHALL CONFORM TO SPECIAL PROVISION "PARTIAL DEPTH PATCH".

THE INFORMATION, INCLUDING ESTIMATED QUANTITIES OF WORK SHOWN ON THESE SHEETS IS BASED ON LIMITED INVESTIGATIONS BY THE TOWN AND IS IN NO WAY WARRANTED TO INDICATE THE TRUE CONDITIONS OR ACTUAL QUANTITIES OR DISTRIBUTION OF QUANTITIES OF WORK WHICH WILL BE REQUIRED.

		REVISIONS	DATE	11/19/2020
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• WENGELL, McDONNELL & COSTELLO • 87 HOLMES ROAD NEWINGTON, CT 06111 (860) 667-9624

PREPARED FOR

TOWN OF WALLINGFORD
45 SOUTH MAIN STREET
WALLINGFORD, CT 06492

REHABILITATION OF SOUTH TURNPIKE ROAD CULVERT OVER MANSION BROOK MISCELLANEOUS DETAILS

						SHEET	14
D – S.	TURNPIKE ROAD		16032.10	_			
SIZE	PROJECT	FILE NAME	NUMBER		REV.	OF	15

F.H.W.A REGION NO. STATE TOWN FEDERAL AID PROJECT NO. YEAR ROUTE NO. SHEET NO. SHEETS


FHWA? CT WALLINGFORD N/A N/A 2020 TR 15 15

NOTES:


1. PLACEMENT OF THE ROCK VANE SHALL BE
DIRECTED IN THE FIELD BY DEEP FISHERIES OR
THEIR AUTHORIZED REPRESENTATIVE. SEE SPECIAL
PROVISION "ROCK VANE".


2. FOOTER ROCKS SHALL SERVE AS THE FOUNDATION FOR THE TOP LAYER OF THE VANE. FOOTER ROCKS SHALL HAVE REASONABLE FLAT TOPS AND BOTTOMS TO ENABLE BETTER PLACEMENT OF THE TOP LAYER OF THE VANE.

3. ALL WORK ASSOCIATED WITH THE INSTALLATION
OF THE ROCK VANE SHALL BE PAID FOR UNDER SPECIAL
PROVISION "ROCK VANE." EXISTING OR NATURAL STREAMBED
MATERIAL TO BE PAID FOR UNDER SPECIAL PROVISION
"EXCAVATION AND REUSE OF EXISTING CHANNEL BOTTOM
MATERIAL" AND, "SUPPLEMENTAL STREAMBED
CHANNEL MATERIAL".

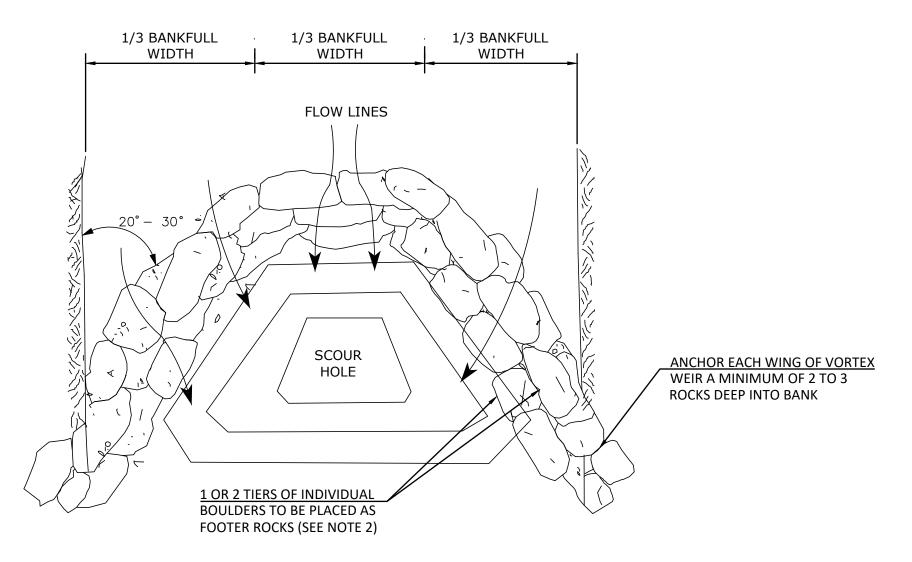

ROCK VANE PLAN VIEW

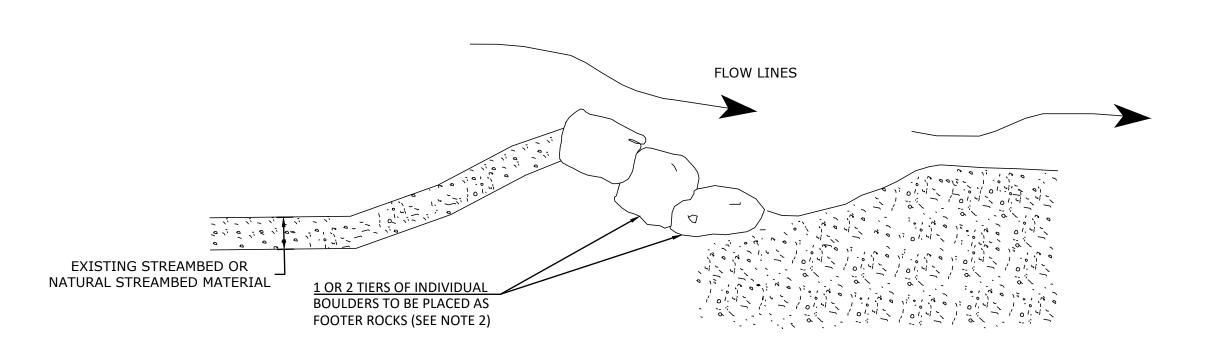

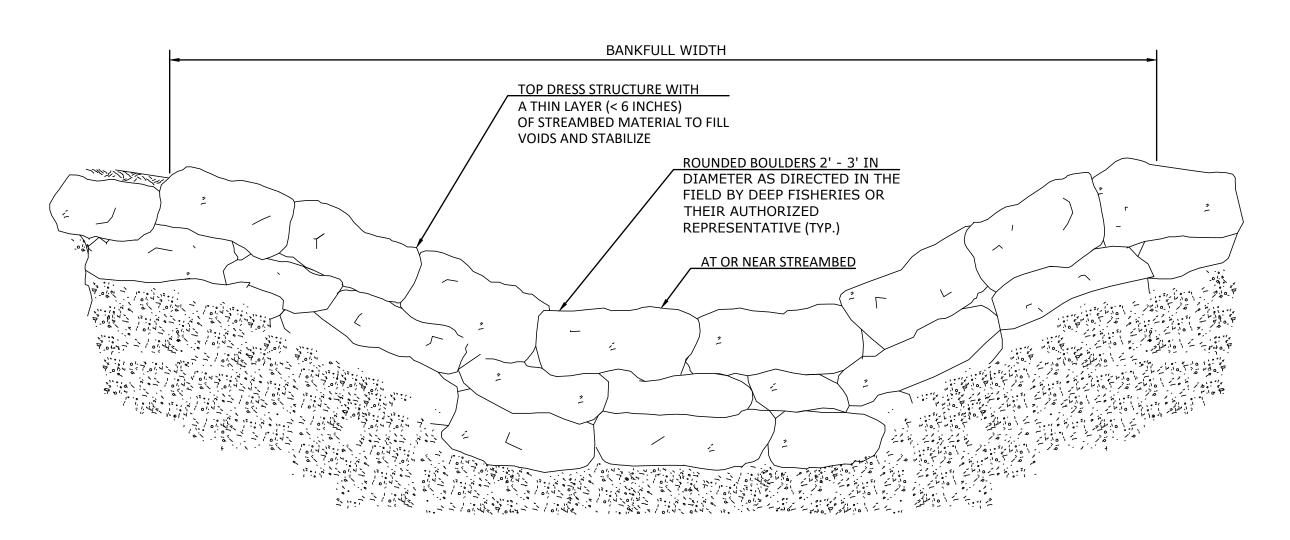

36'-6"± 34'-3"± ROCK VANE FLOW 2 LINES OF LARGE BOULDERS (3'-4' DIAMETER) DRESSED WITH STANDARD RIPRAP EL. 22.39 EL. 22.39 EXISTING/PROPOSED GRADE

DOWNSTREAM SECTION VIEW "A-A"

SCALE: 1" = 5'-0"

ROCK VANE ELEVATION VIEW

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CONSULTING ENGINEERS

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REHABILITATION OF SOUTH TURNPIKE ROAD
CULVERT OVER MANSION BROOK
ROCK VANE DETAILS

						SHEET	15
D – s	TURNPIKE ROAD _		16032.10	-			
SIZE	PROJECT	FILE NAME	NUMBER		REV.	OF	15